LOCUS MAP



ADDITION TO:

MULTI - FAMILY

214 HAMILTON ST WORCESTER, MA

ADDITION
MULTI- FAMILY
BUILDING
214 HAMILTON STREET WORCESTER, MA



5 Brussels Street Building A, Rear 2nd Floor Worcester MA 01610 (D) 774-262-3187 (O) 774-243-6161



LEGEND						
SYMB	OLS		MATERIALS			
1 S-1 S-1 S-1	SECTION DETAIL EXTERIOR ELEVATION		EARTH - LOAM EARTH - FILL GRAVEL SAND CONCRETE CONCRETE MASONRY BRICK			
3068 D D 123	INTERIOR ELEVATION DOOR INDICATION WINDOW INDICATION PARTITION TYPE VERTICAL REF. POINT ROOM NUMBER		BITUMINOUS CONCRETE INSULATION RIGID INSULATION WOOD - FRAMING WOOD - FINISH ZIP PANEL SHEATHING ACOUSTICAL TILE STEEL ALUMINUM METAL - SMALL SCALE			

BUILDING SUMMARY



LIST OF DRAWINGS


Label	Title
T-1	LOCUS MAP, LEGEND, PROJECT NARRATIVE & LIST OF DRAWINGS
T-2	GENERAL NOTES & TYPICAL MOUNTING HEIGHTS
T-3	CODE REVIEW & PATH OF TRAVEL
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L-1	CONSERVATION COMMISSION - ORDER OF CONDITIONS
A-1	PROPOSED - FOUNDATION PLAN
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PROGRESS
SET FOR
ZONING BOARD
OF APPEALS
USE ONLY

LOCUS MAP,
LEGEND,
PROJECT
NARRATIVE & LIST
OF DRAWINGS

22-115	RH/AA/DD
SCALE:	DATE:
AS NOTED	2/26/2024
SHEET NUMBER:	
	4

T-1

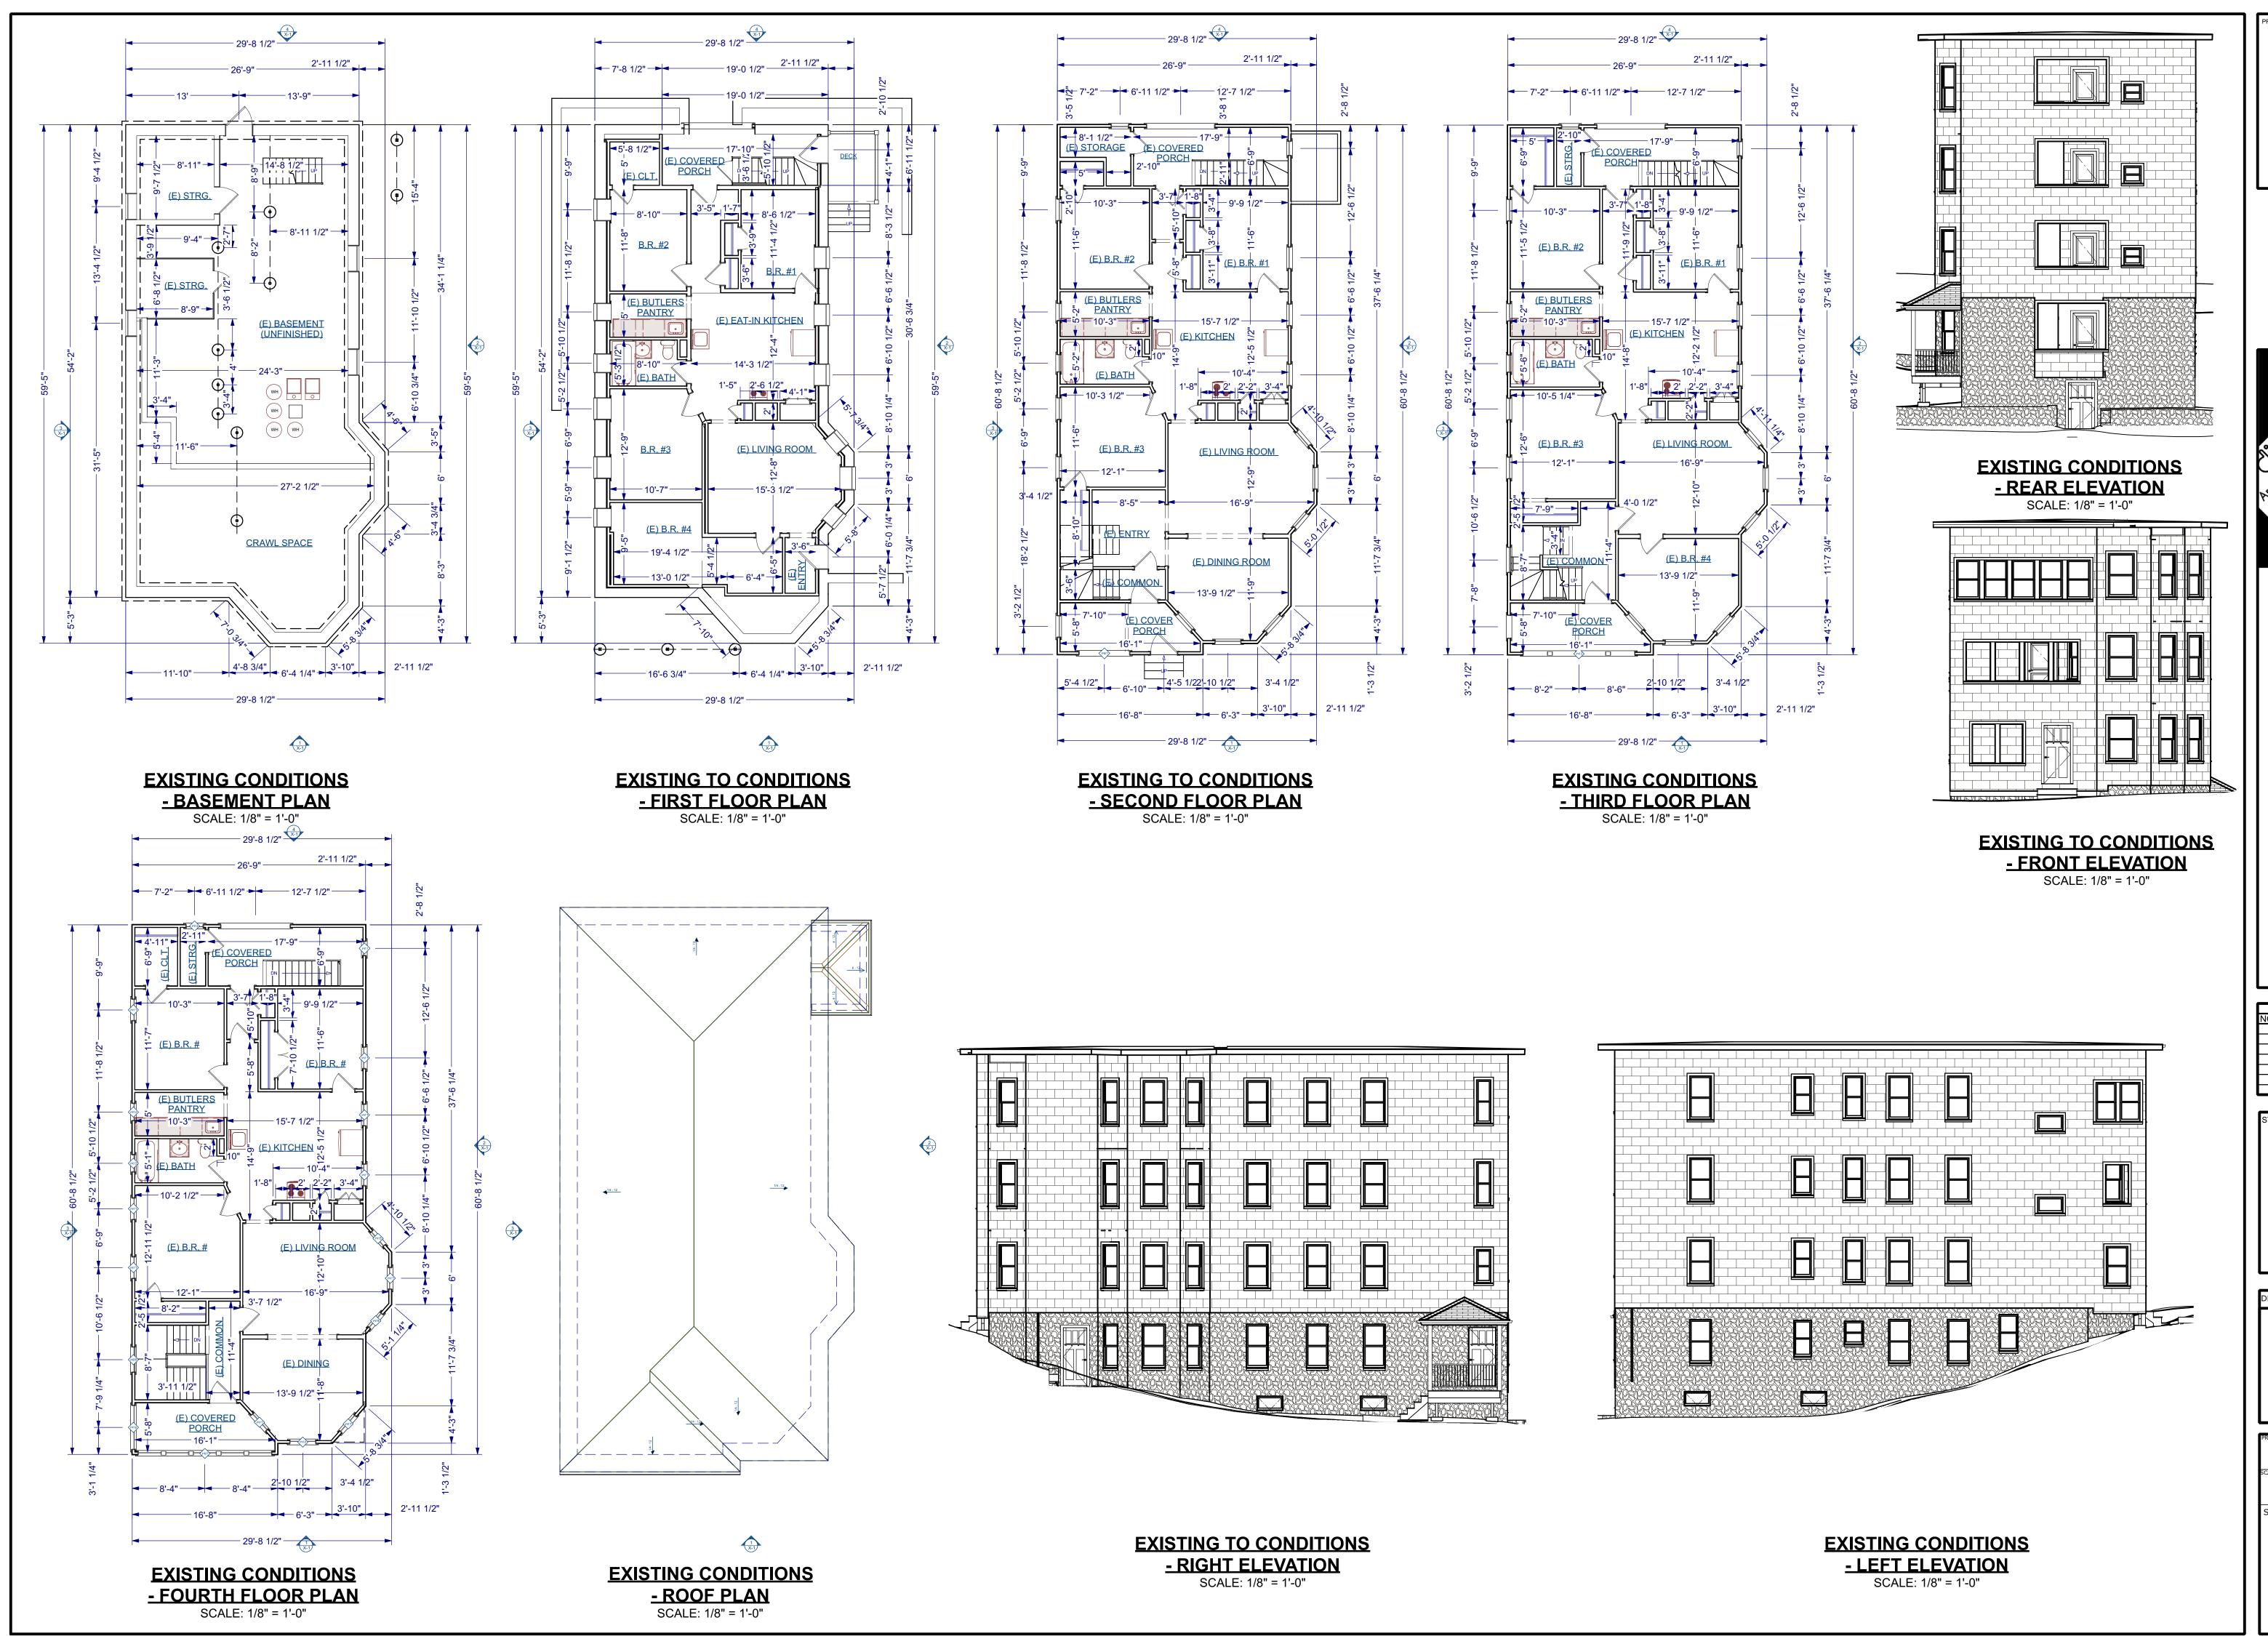

ADDITION

MULTIFAMILY
BUILDING



214 HAMILTON STREET WORCESTER, MA

5 Brussels Street Building A, Rear 2nd Floor Worcester MA 01610 (D) 774-262-3187 (O) 774-243-6161



REVISION TABLE
NO. DATE DESCRIPTION

PROGRESS
SET FOR
ZONING BOARD
OF APPEALS
USE ONLY

WING NAME:

EXISTING
CONDITIONS FLOOR PLANS &
ELEVATIONS

PROJECT NUMBER:	DRAWN BY:
22-115	RH/AA/DD
SCALE:	DATE:
AS NOTED	2/26/2024
AS NOTED SHEET NUMBER:	2/26/2024

X-1

1. From: City of Worcester 2. This issuance is for (check one):

3. To: Applicant: a. First Name REI Group, LLC 108 Bayreuth Place

4. Property Owner (if different from applicant): a. First Name

e. City/Town 5. Project Location: d. Latitude Latitude and Longitude, if known:

City of Worcester Conservation Commission Order of Conditions under Wetlands Protection Ordinance Page 1 of 6

DocuSign Envelope ID: 6901BC20-1D90-44CE-9124-82AFCF0B39EA

d. Mailing Address

ATTACHMENT A Worcester Conservation Commission Special Order of Conditions

City of Worcester Wetlands Protection Ordinance & City of Worcester Wetlands Protection Regulations (City of Worcester Revised Ordinance Part I, Chapter 6) 214 Hamilton Street (CC-2023-078)

Project Description: To construct an addition, stormwater management infrastructure, parking area, utilities, and related site work.

Findings/Waivers: n/a

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VI. General Conditions....

I. Conditions to Meet Prior to and During Construction ... II. Conditions to Meet Before the Start of Any Activity ...

III. Stormwater Management System.... IV. Conditions to Meet During Construction V. Conditions to Meet at Completion of Project

 Office of the Commission is located at the Division of Planning and Regulatory Services (455) Main Street 4th floor, Worcester, MA), which can be contacted by e-mailing

planning@worcesterma.gov or calling 508-799-1400 ext. 31440. • Asterisked (*) conditions are standard conditions of approval for all projects.

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ATTACHMENT A TO ORDER OF CONDITIONS - SPECIAL ORDER OF CONDITIONS BY WORCESTER CONSERVATION COMMISSION 214 HAMILTON STREET (CC-2023-078)

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42. Certificate of Compliance* - Upon completion of the project, the applicant shall request in writing a Certificate of Compliance from the Commission. If the project has been completed in accordance with plans stamped by a registered professional engineer, architect, landscape architect, or land surveyor, certification must include a written statement by such professional certifying the same. a) A certified as-built plan-of-land shall be provided showing final grades, resource areas, and all

43. <u>Deed Condition</u> – Conditions numbered 29 shall extend beyond the Certificate of Compliance, in perpetuity, and shall be referred to in all future deeds to this property. VI. General Conditions

44. Change in Ownership* - If a change in ownership takes place while this Order is still in effect, it is the responsibility of the new owner to notify the Commission of the change and to provide the name of the person responsible for compliance with the Order.

45. Conservation Agent's Power to Act* - With respect to all conditions, except _____, the Conservation mission designates the Conservation Agent, as its Agent with full powers to act on its behalf in administering and enforcing this Order, unless the Agent determines approval from the Commission

46. Right to Inspect* - A member of the Conservation Commission or its Agent may enter and inspect the property and the activity that are the subjects of this Order at all reasonable times, with or without probable cause or prior notice, and until a Certificate of Compliance is issued, for the purpose of evaluating compliance with this Order (and other applicable laws and regulations). 47. Changes to the Plan or Errors & Omissions* -

(a) If any plan, calculation, or other data presented to the Office of the Commission is in error or have omissions, and are deemed significant by the Commissioners or their Agents, all work will stop at the discretion of the Commission, until the discrepancies have been rectified to the Commission's satisfaction.

(b) The applicant must notify the Commission in writing of any changes in the plans or implementation of the proposed activity where mandated by any local, state, or federal agencies having jurisdiction over the proposed activity. If, in the opinion of the Commission any changes in the plans or implementation of the proposed activity so require, then the Commission may modify, amend or rescind this Order in a way consistent with:

M.G.L. Chapter 131, Section 40,

• 310 CMR 10.00, Wetlands Protection,

the City of Worcester's Wetlands Protection Ordinance, and

• the Commission's Wetlands Protection Regulations If any provisions of any conditions, or application thereof is held to be invalid, such invalidity shall not affect any other provisions of this Order. If the Commission deems that a proposed

change is major or substantial, a new hearing may be required. 48. Liability* - The applicant shall indemnify and save harmless the Commonwealth, the City of Worcester, the Conservation Commission, and its Agents against all sites, claims or liabilities of every name and nature arising at any time out of or in consequence of the acts of the Commission or its Agents in the performance of the work covered by this Order and/or failure to comply with the terms and conditions or this Order whether by itself or its employees or subcontractors.

A - 5 | PAGE ATTACHMENT A TO ORDER OF CONDITIONS - SPECIAL ORDER OF CONDITIONS BY WORCESTER CONSERVATION COMMISSION 214 HAMILTON STREET (CC-2023-078

area, utilities, and related site work 7. Conservation Commission Review Trigger: The activities shall occur within the Stormwater

6. Project Description: To construct an addition, stormwater management infrastructure, parking

8. Property recorded at the Registry of Deeds for (attach additional information if more than b. Certificate Number (if registered land) a. Date Notice of Intent Filed b. Date Public Hearing Closed c. Date of Issuance

10. Final Approved Plans and Other Documents (attach additional plan or document references Proposed Multi Family High Rise a. Plan Title Fodera Engineering
b. Prepared By NOI Application Materials Stormwater Report Response to Staff Comments & Revised Drainage Calculations

. Additional Plan or Document Title B. Findings 11. Findings pursuant to the City of Worcester Wetlands Protection Ordinance:

Following the review of the above-referenced Notice of Intent and based on the information provided in this application and presented at the public hearing, this Commission finds that he areas in which work is proposed is significant to the following interests of the Wetlands Protection Ordinance. Check all that apply Public Water Supply

Protection of Wildlife Private Water Supply 12. This Commission hereby finds the project, as proposed, is: (check one of the following boxes)

Approved subject to:

the following conditions which are necessary in accordance with the performance standards set forth in the wetlands regulations. This Commission orders that all work shall be performed in accordance with the Notice of Intent referenced above, the following General Conditions, and any other special conditions attached to this Order. To the extent that the following conditions modify or differ from the plans, specifications, or other proposals submitted with the Notice of Intent, these conditions shall control.

City of Worcester Conservation Commission Order of Conditions under Wetlands Protection Ordinance Page 2 of 6

DocuSign Envelope ID: 6901BC20-1D90-44CE-9124-82AFCF0B39EA

I. Conditions to Meet Prior to and During Construction

21. Person Responsible for Compliance with the Order of Conditions * - A person shall be designated to be responsible to monitor compliance with the Order of Conditions. Their name and contact information (24/7) shall be provided to the Office of the Commission prior to start of any activity.

a) periodic inspections to assure the adequacy and continued effectiveness of erosion and

b) inspections of said controls following 0.5-inch or greater rain events, or after a heavy snow melt. 22. Contract* - This Order of Conditions and all approved plans shall be included as part of any contract and subcontract and shall be posted in a prominently displayed location in the supervisory office on site during all phases of construction

23. Notification* - The applicant shall notify the Office of the Commission a minimum of 48 hours prior to the start of any activity.

II. Conditions to Meet Before the Start of Any Activity 24. Revised Stormwater Report - That a signed & stamped digital copy of a revised stormwater report,

Stormwater Handbook requirements and associated Stormwater Standards and shall incorporate the revised stormwater checklist and drainage calculations reflecting the changes to the stormwater infrastructure as shown on the approved plan with a revision date of 1/16/2024. 25. Pre-Construction Conference* a) The Conservation Commission or its Agents shall conduct a pre-construction conference prior to commencement of activities in each phase of the project. Phasing, if any, shall conform to the

prepared by a professional engineer, shall be provided to the Office of the Commission prior to

commencement of any work. Said report must demonstrate compliance with the Massachusetts

b) The property owner / applicant and any person performing work that is subject to this Order are responsible for understanding and complying with the requirements of this Order, the Wetlands Protection Act, 310 CMR 10.00 and City of Worcester Wetlands Protection Ordinance and Regulations. Said persons shall acknowledge such in writing prior to commencement of

26. Inspections Prior to Site Preparation and Site Work* - Erosion and sediment controls shall be nstalled and verified, in compliance with final approved plans, by the Commission or its Agents prior to the commencement of any excavation, grubbing and/or stumping of vegetation, grading, construction, or other site preparation

27. Construction Schedule* - Submit a Construction Schedule consistent with Work Sequencing plans provided to the Office of the Commission prior to the start of any activities.

III. Stormwater Management System

28. Catch Basins* -

a) The paved roadways and parking lots shall be bermed and shall be installed with standard City of Worcester catch basins

b) Prior to start of activity on site that causes soil erosion and sedimentation, catch basin filter traps shall be installed in the existing and new catch basins.

c) Catch basins shall be cleaned as warranted during construction to keep them clear of sediment, and minimum twice a year thereafter.

A - 2 | PAGE ATTACHMENT A TO ORDER OF CONDITIONS - SPECIAL ORDER OF CONDITIONS BY WORCESTER CONSERVATION COMMISSION 214 HAMILTON STREET (CC-2023-078)

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C. Signatures This Order is valid for three years, unless otherwise specified as a special 1. Date of Issuance condition pursuant to General Conditions #4, from the date of issuance. Please indicate the number of members who will sign this form. 2. Number of Signers

his Order must be signed by a majority of the Conservation Commission.

copy also must be mailed or hand delivered at the same time to the property owner, if different from The names typed below represent the intent to sign the foregoing document in accordance with

The Order must be mailed by certified mail (return receipt requested) or hand delivered to the applicant. A

Duly authorized by Ch.110G and recorded at Worcester Registry of Deeds in Book 62537 Page 329.

Joseph Clargeotte Stuart Einsteiner Timothy Magliard Lindsay Mystrom Lindsay Nystrom andrew Truman Andrew Truman

by certified mail, return receipt requested, on by hand delivery on 2/15/2024

D. Appeals

Appeal from a decision of the Conservation Commission shall be taken in accordance with law to the Superior Court or other body of competent jurisdiction. Any such appeal shall be taken within ten (10) days from the date from the receipt of such decision and shall not relieve the individual of the responsibility of taking an appeal to Department of Environmental Protection if such is required under said regulations.

No work may proceed until the appeal on the Commission's decision on a Notice of Intent

DocuSign Envelope ID: 6901BC20-1D90-44CE-9124-82AFCF0B39EA

B. Findings (cont.)

Denied because:

DocuSign Envelope ID: 6901BC20-1D90-44CE-9124-82AFCF0B39EA

The proposed work cannot be conditioned to meet the performance standards set forth in the wetland regulations. Therefore, work on this project may not go forward unless and until a new Notice of Intent is submitted which provides measures which are adequate to protect the interests of the Ordinance, and a final Order of Conditions is issued. A description of the performance standards which the proposed work cannot meet is attached to this

☐ The information submitted by the applicant is not sufficient to describe the site, the work, or the effect of the work on the interests identified in the Wetlands Protection Act. Therefore, work on this project may not go forward unless and until a revised Notice of Intent is submitted which provides sufficient information and includes measures which are adequate to protect the Ordinance's interests, and a final Order of Conditions is issued. A description of the specific information which is lacking and why it is necessary is attached to this Order.

C. General Conditions Under Wetlands Protection Ordinance

The following conditions are only applicable to Approved projects

1. Failure to comply with all conditions stated herein, and with all related statutes and other egulatory measures, shall be deemed cause to revoke or modify this Order.

2. The Order does not grant any property rights or any exclusive privileges; it does not authorize any injury to private property or invasion of private rights.

with all other applicable federal, state, or local statutes, ordinances, bylaws, or regulations

3. This Order does not relieve the permittee or any other person of the necessity of complying

4. The work authorized hereunder shall be completed within three years from the date of this Order unless either of the following apply: a. the work is a maintenance dredging project as provided for in the Act; or

b. the time for completion has been extended to a specified date more than three years, but less than five years, from the date of issuance. If this Order is intended to be valid for more than three years, the extension date and the special circumstances warranting the extended time period are set forth as a special condition in this Order.

5. This Order may be extended by the issuing authority for one or more periods of up to three years each upon application to the issuing authority at least 30 days prior to the expiration

date of the Order. 6. If this Order constitutes an Amended Order of Conditions, this Amended Order of Conditions does not extend the issuance date of the original Final Order of Conditions and the Order will expire on _____ unless extended in writing by the Department.

7. Any fill used in connection with this project shall be clean fill. Any fill shall contain no trash, refuse, rubbish, or debris, including but not limited to lumber, bricks, plaster, wire, lat paper, cardboard, pipe, tires, ashes, refrigerators, motor vehicles, or parts of any of the

City of Worcester Conservation Commission Order of Conditions under Wetlands Protection Ordinance Page 3 of 6

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29. Stormwater Management System Maintenance* - The stormwater management system shall be naintained in accordance with the approved design plans and Operation and Maintenance Plan on file with the Office of the Commission. The system shall be maintained in good hydraulic condition (e.g. any accumulated silt/sediment shall be removed; the system shall be kept free of any litter. refuse, or other extraneous matter, etc.). This condition shall extend in perpetuity beyond the issuance of the Certificate of Compliance.

IV. Conditions to Meet During Construction

30. Limit of Work* - No removal, filling, dredging or altering of jurisdictional areas shall take place outside the approved work under this Order of Condition.

31. Work Sequencing* - Activities shall take place in accordance with all phasing and sequencing shown on the plan and/or provided in the application materials on file with the Office of the ommission and shall follow any lot opening restrictions otherwise provided herein

32. Fill Material - the fill material used at the location of the proposed subsurface infiltration unit shall

be suitable so as to allow infiltration in accordance with the system's design. 33. Stormwater Infrastructure Certification - A registered Professional Engineer, currently licensed to practice within the Commonwealth of Massachusetts, shall provide a written certification that the stormwater system has been installed in substantial compliance with the approved plans and that

the infrastructure functions as designed. Photos shall be included of the installed unit prior to

a) <u>Erosion and Sediment Controls</u>* - All erosion and sediment controls shall be monitored, maintained, and adjusted for the duration of the project to prevent adverse impacts to

iurisdictional areas. Additional erosion and sediment controls may be utilized on site as needed b) Off Site Impacts* - There shall be no off-site erosion, flooding, ponding, or flood-related damage from runoff caused by the project activities.

c) <u>Unanticipated Drainage or Erosion</u>* - The applicant shall control any unanticipated drainage and/or erosion conditions that may cause damage to jurisdictional areas and/or abutting or downstream properties. Said control measures shall be implemented immediately upon need The Office of the Conservation Commission shall be notified if such conditions arise and of the

d) Soil Stabilization due to Delay in Work* - If there is an interruption of more than 10, but less than 0 days between completion of grading and revegetation, the applicant shall sow all disturbed areas with annual rye grass to prevent erosion. If soils are to be exposed for longer than 60 days, a temporary cover of rye or other grass should be established following US Soil Conservation Services procedures, as recently amended, to prevent erosion and sedimentation Once final grading is complete, loaming and seeding of final cover should be completed

e) <u>Grading of Slopes</u>*-

i. >40% Slope – Slopes shall not exceed those specified in the plans approved by the Conservation Commission. Any slope equal to or greater than 40% (1 vertical to 2 1/2 horizontal) shall be stabilized with erosion control matting.

ii. <40% Slope – Final grades of vegetated areas shall not exceed a slope of 1 vertical to 2 1/2 horizontal (40%) and shall be stabilized to prevent erosion, particularly during the construction period.

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ATTACHMENT A TO ORDER OF CONDITIONS - SPECIAL ORDER OF CONDITIONS BY WORCESTER CONSERVATION COMMISSION 214 HAMILTON STREET (CC-2023-078)

DocuSign Envelope ID: 6901BC20-1D90-44CE-9124-82AFCF0B39EA

E. Recording Information

Document Number

Signature of Applicant

Prior to commencement of work, this Order of Conditions must be recorded in the Registry of Deeds for the district in which the land is located, within the chain of title of the affected property. In the case of recorded land, the Final Order shall also be noted in the Registry's Grantor Index under the name of the owner of the land subject to the Order. In the case of registered land, this Order shall also be noted on the Land Court Certificate of Title of the owner of the land subject to the Order of Conditions. The recording information on this page shall be submitted to the Conservation Commission listed below.

Conservation Commission Detach on dotted line, have stamped by the Registry of Deeds and submit to the Conservation Conservation Commission Please be advised that the Order of Conditions for the Project at: Project Location Conservation Commission File Number Has been recorded at the Registry of Deeds of: for: Property Owner and has been noted in the chain of title of the affected property in: In accordance with the Order of Conditions issued on: If recorded land, the instrument number identifying this transaction is: Instrument Number If registered land, the document number identifying this transaction is:

Order of Conditions under Wetlands Protection Ordinance Page 6 of 6

8. This Order is not final until all administrative appeal periods from this Order have elapsed, or if such an appeal has been taken, until all proceedings before the Department have been

9. No work shall be undertaken until the Order has become final and then has been recorded in the Registry of Deeds for the district in which the land is located, within the chain of title of the affected property. In the case of recorded land, the Final Order shall also be noted in the Registry's Grantor Index under the name of the owner of the land upon which the proposed work is to be done. In the case of the registered land, the Final Order shall also be noted on the Land Court Certificate of Title of the owner of the land upon which the proposed work is done. The recording information shall be submitted to the Conservation mmission on the form at the end of this Order, which form must be stamped by the Registry of Deeds, prior to the commencement of work.

10. A sign shall be displayed at the site not less than two square feet or more than three square feet in size bearing the words "City of Worcester Conservation Commission File Number CC-2023-078.*

11. Within thirty (30) days of completion of the work described herein, the applicant shall submit a Request for Certificate of Compliance to the Conservation Comr

12. The work shall conform to the plans and special conditions referenced in this order 13. Any change to the plans identified in Condition #12 above shall require the applicant to inquire of the Conservation Commission in writing whether the change is significant enough to require the filing of a new Notice of Intent.

14. The Agent or members of the Conservation Commission shall have the right to enter and inspect the area subject to this Order at reasonable hours to evaluate compliance with the conditions stated in this Order, and may require the submittal of any data deemed necessary by the Conservation Commission or Department for that evaluation

15. This Order of Conditions shall apply to any successor in interest or successor in control of the property subject to this Order and to any contractor or other person performing work conditioned by this Order.

16. All sedimentation barriers shall be maintained in good repair until all disturbed areas have been fully stabilized with vegetation or other means. At no time shall sediments be deposited in a wetland or water body. During construction, the applicant or his/her designee shall inspect the erosion controls on a daily basis and shall remove accumulated sediment as needed. The applicant shall immediately control any erosion problems that occur at the site and shall also immediately notify the Conservation Commission, which reserves the right to require additional erosion and/or damage prevention controls it may deem necessary. Sedimentation barriers shall serve as the limit of work unless another limit of work line has been approved by this Order.

17. The Commission orders that all work shall be performed in accordance with the following conditions and with the Notice of Intent referenced above. To the extent that the following conditions modify or differ from the plans, specifications, or other proposals submitted with the Notice of Intent, the conditions shall control

18. The special conditions relating to municipal ordinance or bylaw are as follows (if you need more space for additional conditions, attach a text document): See Attachment A.

City of Worcester Conservation Commission Order of Conditions under Wetlands Protection Ordinance Page 4 of 6

DocuSign Envelope ID: 6901BC20-1D90-44CE-9124-82AFCF0B39EA

f) Stockpile Maintenance* - Any stockpiling of loose materials shall be properly stabilized to prevent erosion into and sedimentation of jurisdictional areas. Preventative controls such as

strawbales or erosion control matting shall be implemented to prevent such an occurrence. g) Stockpile Location - In no case shall any soil or excavated material be stockpiled within 50 feet of any wetland, floodplain, or storm drain inlet

h) Site Stabilization Prior to Winter* - Prior to winter, exposed soils shall be stabilized (e.g. with emonstrated vegetative growth, impermeable barriers, erosion control blankets, etc.).

35. Invasive Insects* a) Plantings - No trees to be planted shall be species susceptible to the Asian Longhorned Beetle b) Wood Removal - All tree, brush & wood removal shall adhere to the most recently amended

requirements set forth by the Massachusetts Department of Conservation & Recreation for any project located in the Asian Longhorned Beetle Quarantine Zone. 36. <u>Dust Control</u>* - Provisions for dust control shall be provided during all construction and demolition ctivities. Such provisions shall be conducted in compliance with all City of Worcester Water Use Restrictions, if in effect, during such activities.

37. Dewatering* - If dewatering is required, a) Notice of such activities shall be given to the Office of the Commission within 24 hours of

b) There shall be no discharge of untreated dewatered stormwater or groundwater to jurisdictional areas either by direct or indirect discharge to existing drainage systems; c) Any discharge to surface waters or drainage structures must be visibly free of sediment; d) To the maximum extent practicable, proposed dewatering activities should be located outside of

at all times when the pumps are running; 38. Cement Truck Washing - Cement trucks shall not discharge washout effluent directly to any

the 100' buffer. If such activities must be located within the 100' buffer, they shall be monitored

source area, the 30' buffer thereto, or into any drainage system. Designated washout areas shall be located out of the 100 buffer zone to any wetland.

a) No fuel, oil, or other pollutants shall be stored in any resource area or the buffer zone thereto, unless specified in this Order

b) No refueling shall take place within resource areas or 100-ft to a resource area; c) The applicant shall take all necessary precautions to prevent discharge or spillage of fuel, oil or other pollutants onto any part of the site;

d) A spill kit shall be present on site at all times. V. Conditions to Meet at Completion of Project 40. Site Stabilization* - All disturbed areas shall be properly stabilized with well-established perennial

vegetation or other approved methods before the project is considered complete. 41. Erosion and Sediment Controls* - Erosion and sediment controls shall not be removed from the site until all disturbed areas have been stabilized with final vegetative cover and approval has been received from the Commission or its Agents to do so. The controls must then be removed within two weeks of receipt of that certification.

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ATTACHMENT A TO ORDER OF CONDITIONS - SPECIAL ORDER OF CONDITIONS BY WORCESTER CONSERVATION COMMISSION 214 HAMILTON STREET (CC-2023-078)

<u>ADDITION</u>

MULTI-

214 HAMILTON STREET

5 Brussels Street

Building A, Rear 2nd Floor

Worcester MA 01610

(D) 774-262-3187

(O) 774-243-6161

Info@acropolisdesign.org


WORCESTER, MA

PROGRESS

DRAWING NAME:

CONSERVATION COMMISSION ORDER OF

RH/AA/DD AS NOTED 2/26/2024 SHEET NUMBER:

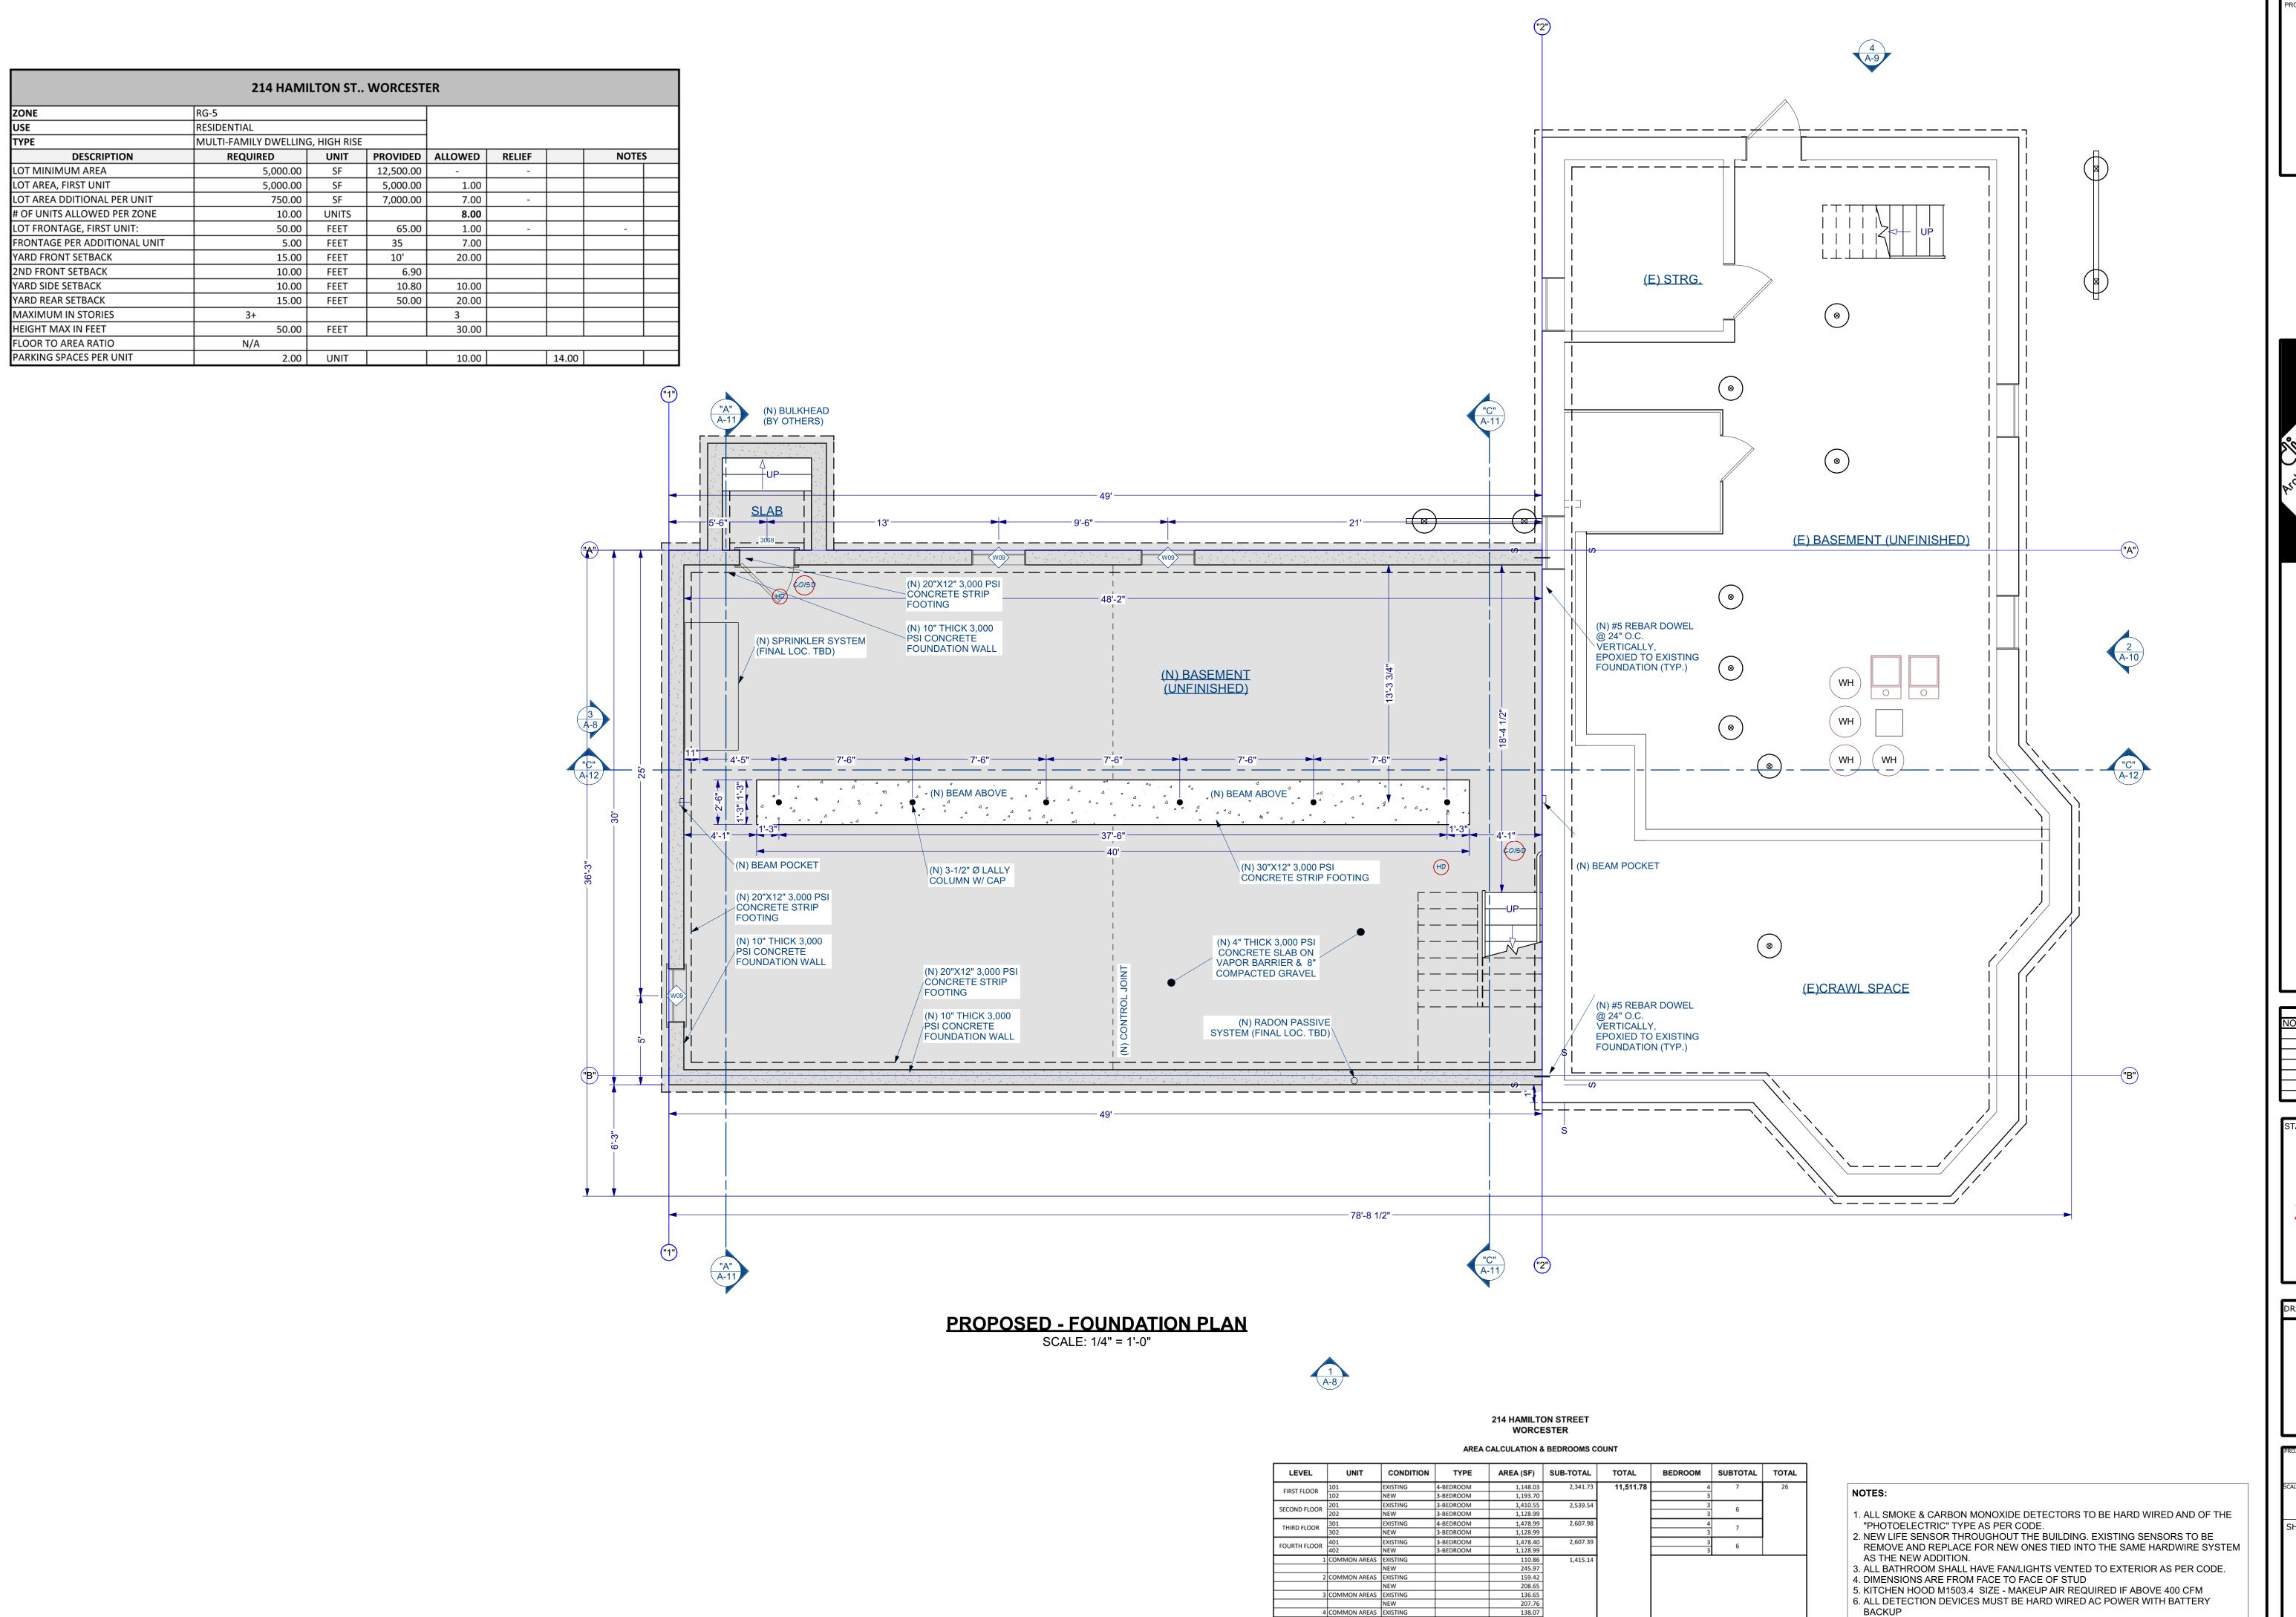

PROJECT NAME:

ADDITION

MULTI-FAMILY BUILDING

214 HAMILTON STREET WORCESTER, MA



5 Brussels Street Building A, Rear 2nd Floor Worcester MA 01610 (D) 774-262-3187 (O) 774-243-6161




REVISION TABLE
NO. DATE DESCRIPTION

PROGRESS
SET FOR
ZONING BOARD
OF APPEALS
USE ONLY

DRAWING NAME:

PROPOSED -FOUNDATION PLAN

PROJECT NUMBER:	DRAWN BY:
22-115	RH/AA/DD
SCALE:	DATE:
AS NOTED	2/26/2024
SHEET NUMBER:	

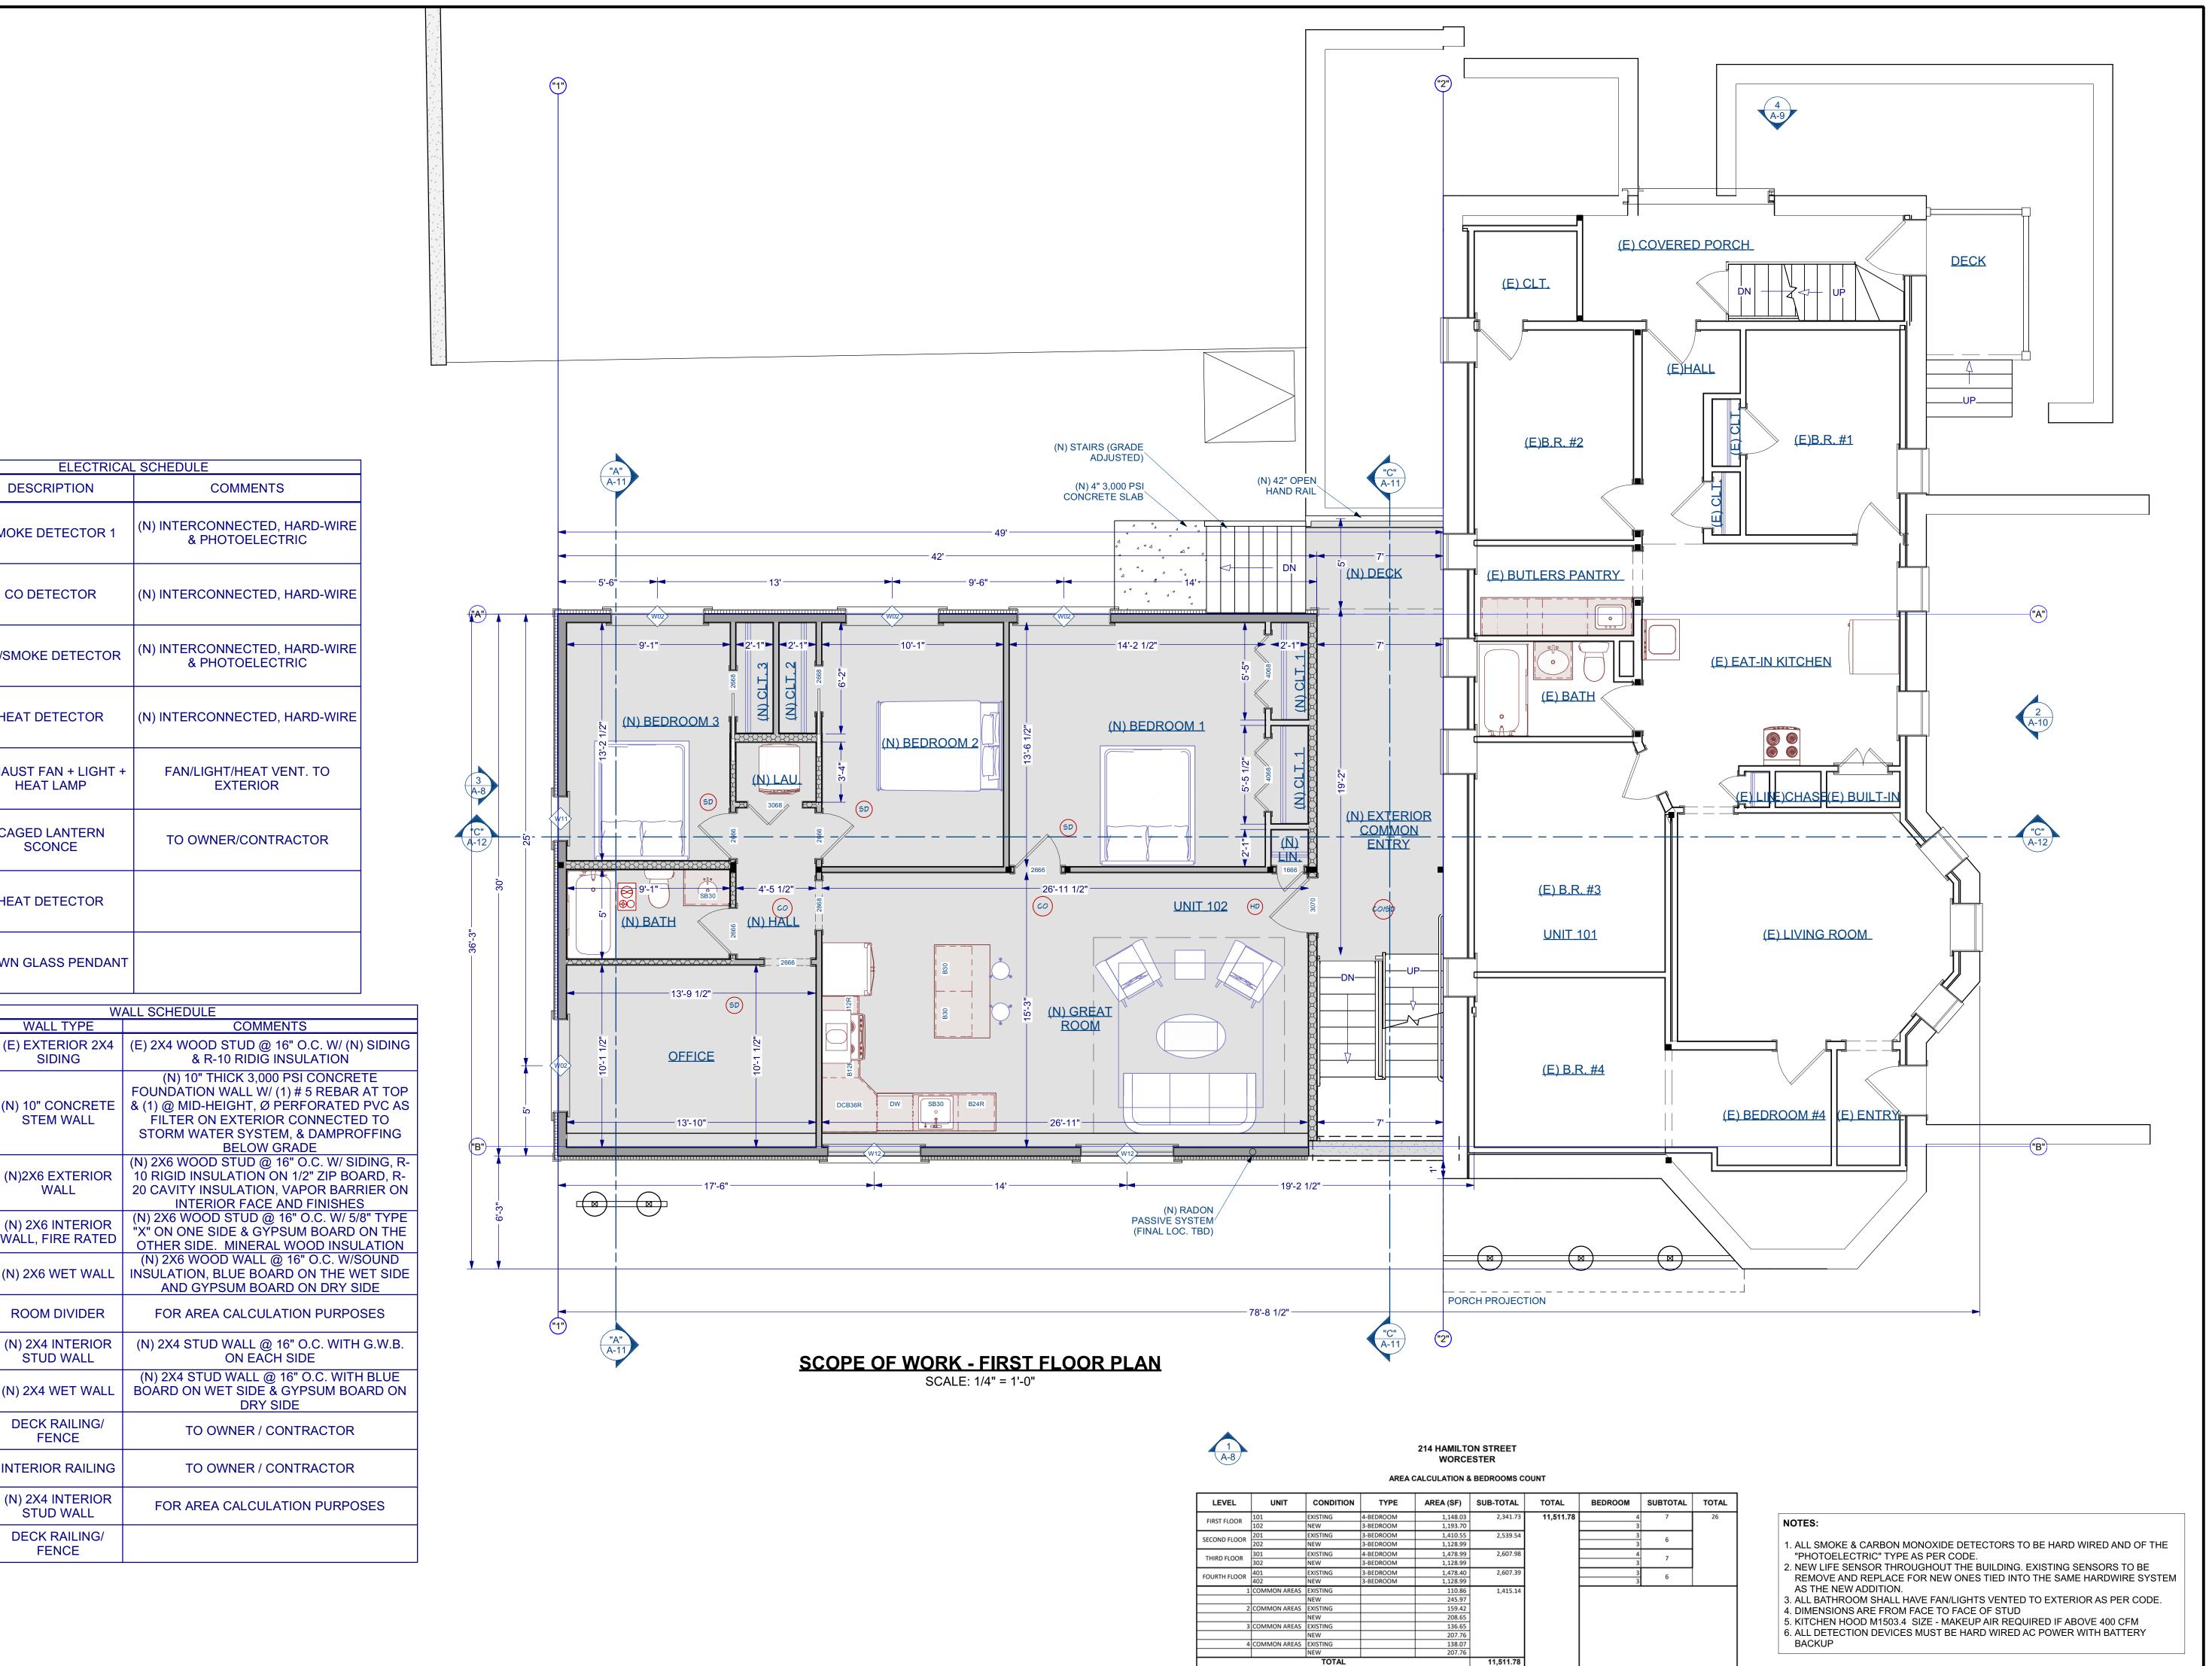

COMMENTS

& PHOTOELECTRIC

& PHOTOELECTRIC

FAN/LIGHT/HEAT VENT. TO

EXTERIOR

TO OWNER/CONTRACTOR

COMMENTS

BELOW GRADE

ON EACH SIDE

DRY SIDE

DESCRIPTION

SMOKE DETECTOR 1

CO DETECTOR

CO/SMOKE DETECTOR

HEAT DETECTOR

EXHAUST FAN + LIGHT -

HEAT LAMP

CAGED LANTERN

SCONCE

HEAT DETECTOR

BLOWN GLASS PENDANT

SIDING

(N) 10" CONCRETE

STEM WALL

(N)2X6 EXTERIOR

WALL

(N) 2X6 INTERIOR

WALL, FIRE RATED

ROOM DIVIDER

(N) 2X4 INTERIOR

STUD WALL

(N) 2X4 WET WALL

DECK RAILING/

FENCE

INTERIOR RAILING

(N) 2X4 INTERIOR

STUD WALL

DECK RAILING/

FENCE

(N) 2X6 WET WALL

2D SYMBOL WALL TYPE

_ _ _ _ _

RAAAAAA

WALL SCHEDULE

SYMBOL


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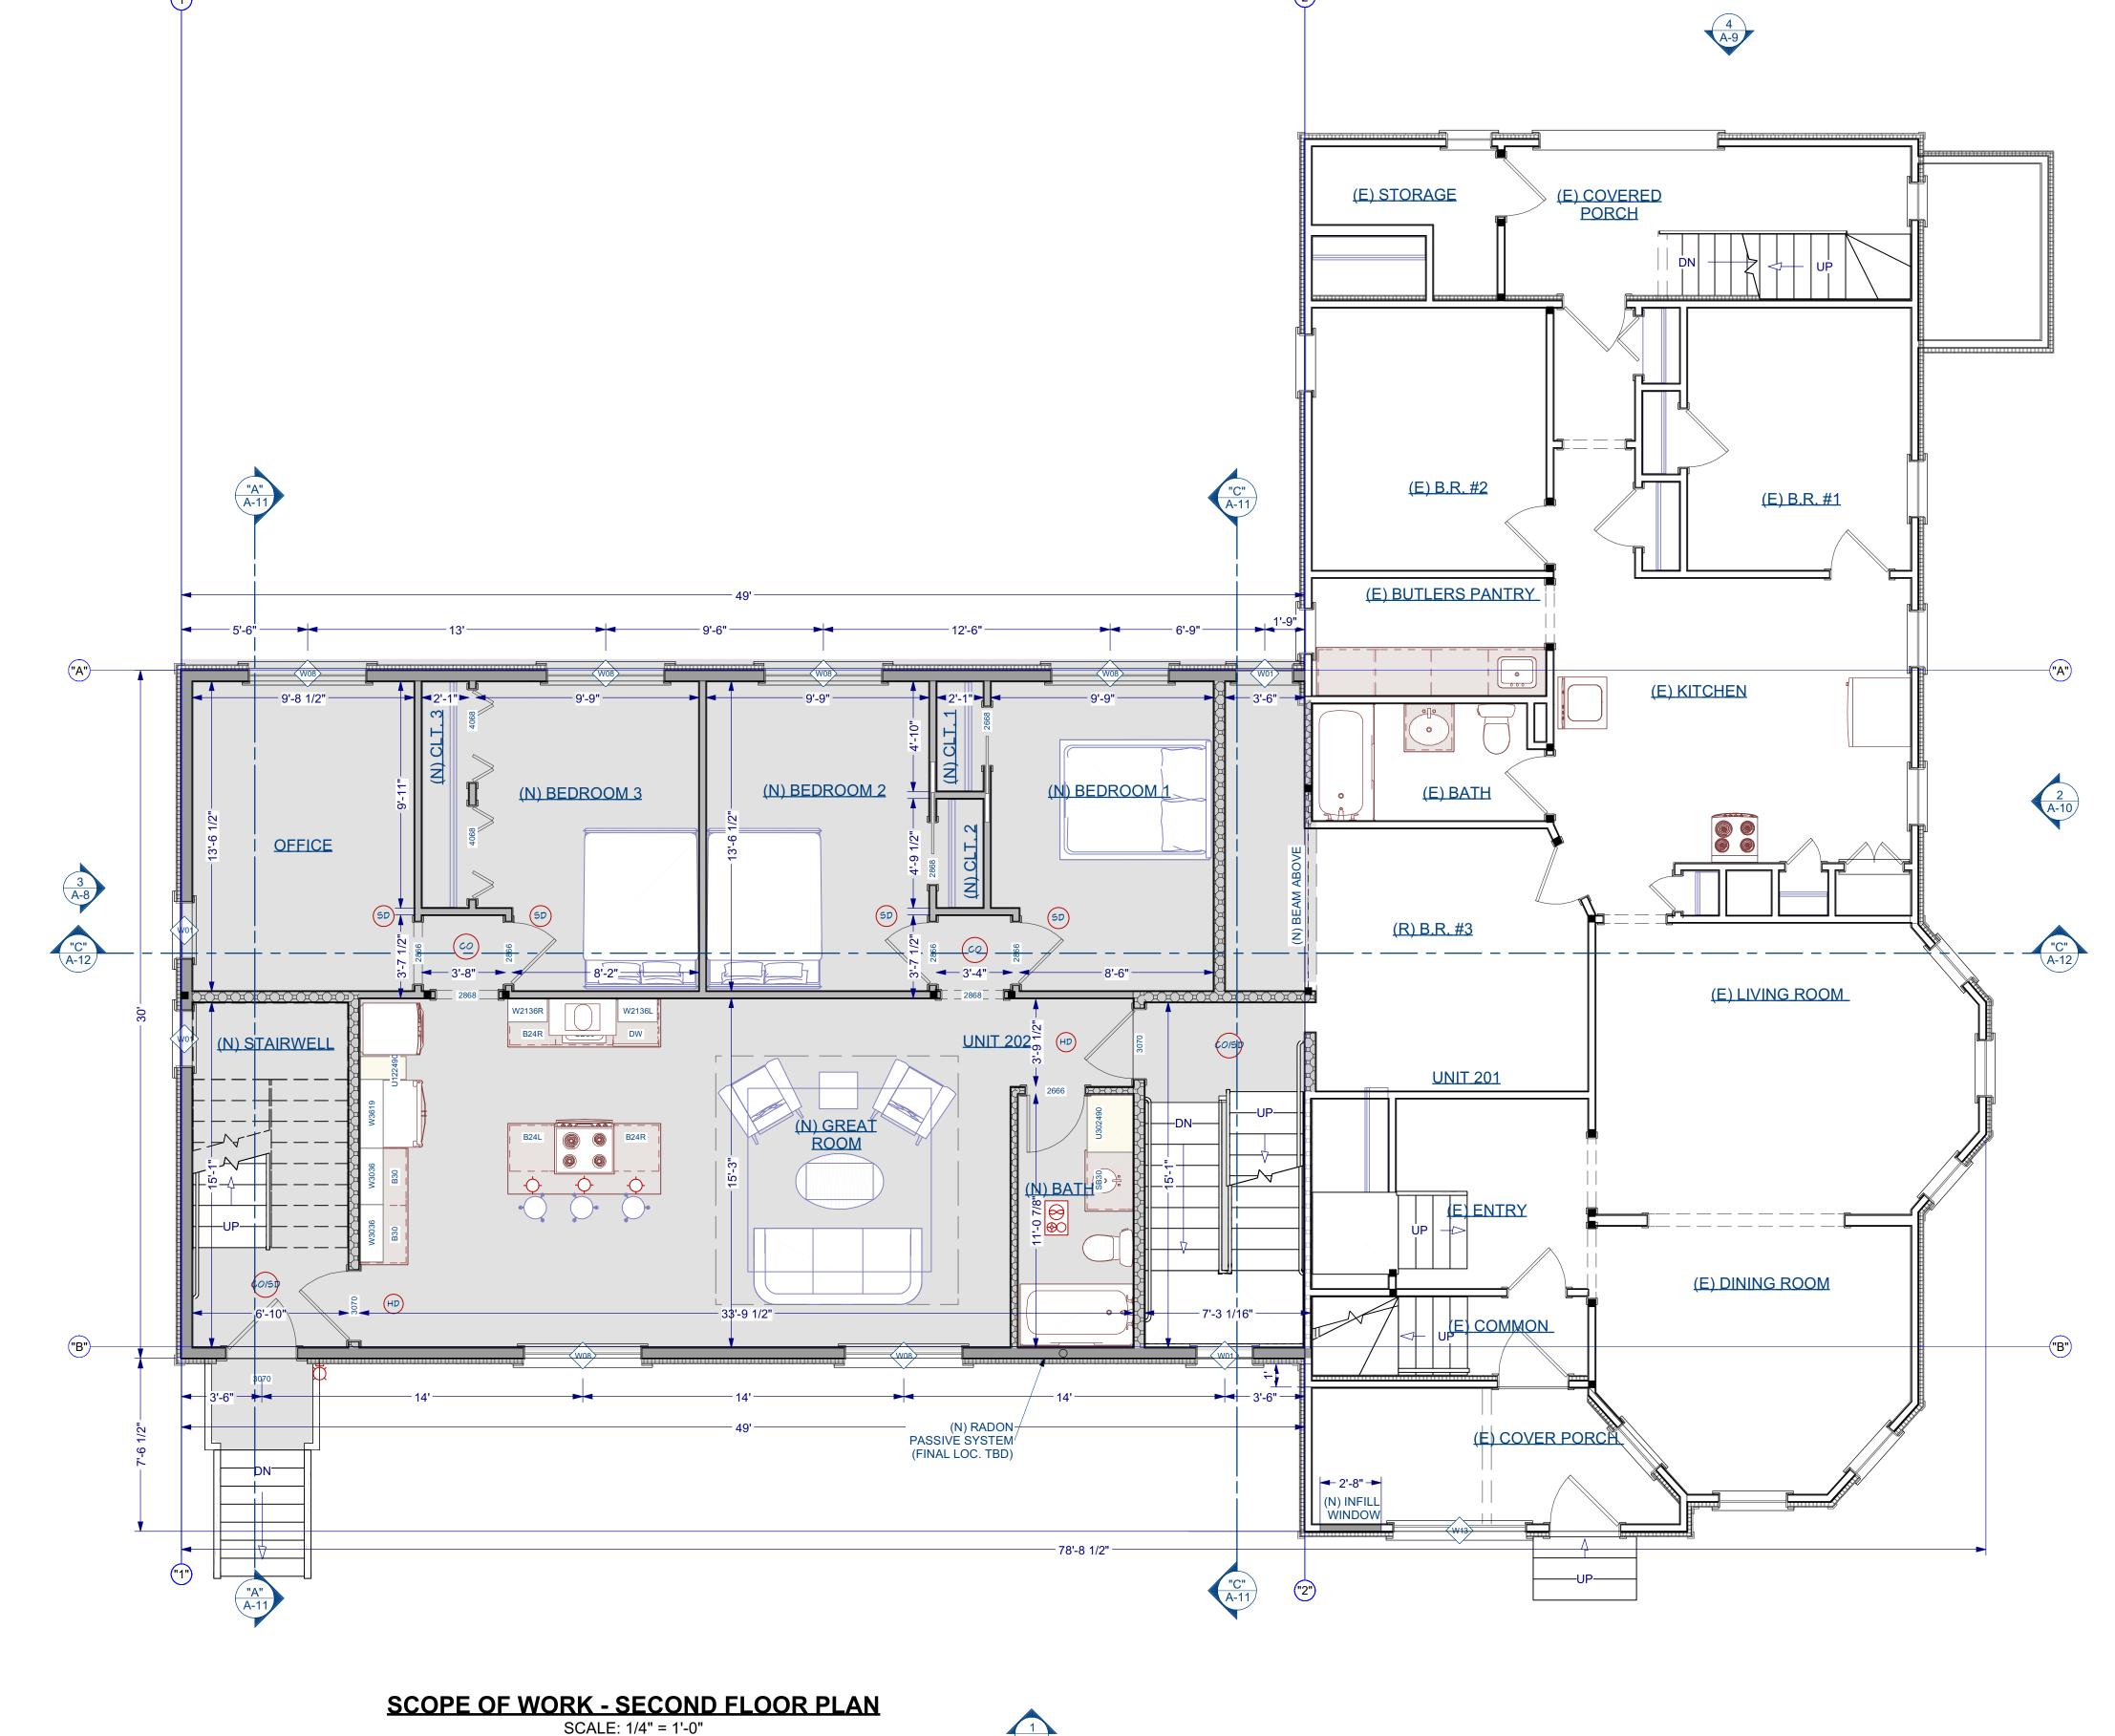


PROGRESS SET FOR **ZONING BOARD** OF APPEALS **USE ONLY**

DRAWING NAME:

SCOPE OF WORK - FIRST FLOOR PLAN

PROJECT NUMBER:	DRAWN BY:
22-115	RH/AA/DD
SCALE:	DATE:
AS NOTED	2/26/2024
SHEET NUMBER:	

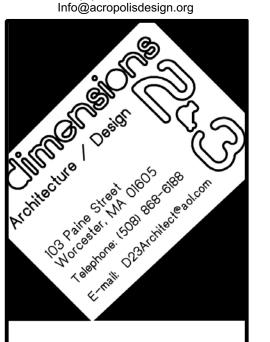

COMMENTS

(N) INTERCONNECTED, HARD-WIRE

& PHOTOELECTRIC

(N) INTERCONNECTED, HARD-WIRE

(N) INTERCONNECTED, HARD-WIRE

& PHOTOELECTRIC

(N) INTERCONNECTED, HARD-WIRE

FAN/LIGHT/HEAT VENT. TO

EXTERIOR

TO OWNER/CONTRACTOR

COMMENTS

& R-10 RIDIG INSULATION (N) 10" THICK 3,000 PSI CONCRETE FOUNDATION WALL W/ (1) # 5 REBAR AT TOP

& (1) @ MID-HEIGHT, Ø PERFORATED PVC AS FILTER ON EXTERIOR CONNECTED TO

STORM WATER SYSTEM, & DAMPROFFING **BELOW GRADE** (N) 2X6 WOOD STUD @ 16" O.C. W/ SIDING, R-

10 RIGID INSULATION ON 1/2" ZIP BOARD, R-

20 CAVITY INSULATION, VAPOR BARRIER ON

INTERIOR FACE AND FINISHES

(N) 2X6 WOOD STUD @ 16" O.C. W/ 5/8" TYPE

"X" ON ONE SIDE & GYPSUM BOARD ON THE

OTHER SIDE. MINERAL WOOD INSULATION

(N) 2X6 WOOD WALL @ 16" O.C. W/SOUND

INSULATION, BLUE BOARD ON THE WET SIDE

AND GYPSUM BOARD ON DRY SIDE

FOR AREA CALCULATION PURPOSES

(N) 2X4 STUD WALL @ 16" O.C. WITH G.W.B.

ON EACH SIDE (N) 2X4 STUD WALL @ 16" O.C. WITH BLUE

BOARD ON WET SIDE & GYPSUM BOARD ON

DRY SIDE

TO OWNER / CONTRACTOR

TO OWNER / CONTRACTOR

FOR AREA CALCULATION PURPOSES

DESCRIPTION

SMOKE DETECTOR 1

CO DETECTOR

CO/SMOKE DETECTOR

HEAT DETECTOR

EXHAUST FAN + LIGHT -

HEAT LAMP

CAGED LANTERN

SCONCE

HEAT DETECTOR

BLOWN GLASS PENDANT

SIDING

(N) 10" CONCRETE

STEM WALL

(N)2X6 EXTERIOR

WALL

(N) 2X6 INTERIOR

WALL, FIRE RATED

ROOM DIVIDER

(N) 2X4 INTERIOR

STUD WALL

DECK RAILING/

FENCE

INTERIOR RAILING

(N) 2X4 INTERIOR

STUD WALL

DECK RAILING/

FENCE

(N) 2X6 WET WALL

(N) 2X4 WET WALL

2D SYMBOL WALL TYPE

AAAAAA

WALL SCHEDULE

(E) EXTERIOR 2X4 (E) 2X4 WOOD STUD @ 16" O.C. W/ (N) SIDING

SYMBOL



214 HAMILTON STREET WORCESTER AREA CALCULATION & BEDROOMS COUNT

LEVEL	UNIT	CONDITION	TYPE	AREA (SF)	SUB-TOTAL	TOTAL	BEDROOM	SUBTOTAL	TOTAL
FIRST FLOOR	101	EXISTING	4-BEDROOM	1,148.03	2,341.73	11,511.78	4	7	26
FIRST FLOOR	102	NEW	3-BEDROOM	1,193.70			3		
SECOND FLOOR	201	EXISTING	3-BEDROOM	1,410.55	2,539.54	[3	6	
SECOND FLOOR	202	NEW	3-BEDROOM	1,128.99		[3	ь	
THIRD FLOOR	301	EXISTING	4-BEDROOM	1,478.99	2,607.98	- [4	-	
THIRD FLOOR	302	NEW	3-BEDROOM	1,128.99		Ī	3	′	
FOURTH FLOOR	401	EXISTING	3-BEDROOM	1,478.40	2,607.39	i i	3		
FOOK I H FLOOK	402	NEW	3-BEDROOM	1,128.99		i	3	6	
1	COMMON AREAS	EXISTING		110.86	1,415.14				
		NEW		245.97					
2	COMMON AREAS	EXISTING		159.42					
		NEW		208.65					
3	COMMON AREAS	EXISTING		136.65					
		NEW		207.76					
4	COMMON AREAS	EXISTING		138.07					
		NEW		207.76					

BACKUP

- 1. ALL SMOKE & CARBON MONOXIDE DETECTORS TO BE HARD WIRED AND OF THE
- "PHOTOELECTRIC" TYPE AS PER CODE. 2. NEW LIFE SENSOR THROUGHOUT THE BUILDING. EXISTING SENSORS TO BE REMOVE AND REPLACE FOR NEW ONES TIED INTO THE SAME HARDWIRE SYSTEM
- AS THE NEW ADDITION.
- 4. DIMENSIONS ARE FROM FACE TO FACE OF STUD 5. KITCHEN HOOD M1503.4 SIZE - MAKEUP AIR REQUIRED IF ABOVE 400 CFM 6. ALL DETECTION DEVICES MUST BE HARD WIRED AC POWER WITH BATTERY

3. ALL BATHROOM SHALL HAVE FAN/LIGHTS VENTED TO EXTERIOR AS PER CODE.

<u>ADDITION</u> **MULTI-FAMILY** BUILDING



214 HAMILTON STREET WORCESTER, MA

5 Brussels Street Building A, Rear 2nd Floor (D) 774-262-3187 (O) 774-243-6161




PROGRESS SET FOR **ZONING BOARD** OF APPEALS **USE ONLY**

DRAWING NAME:

SCOPE OF WORK - SECOND FLOOR PLAN

PROJECT NUMBER:	DRAWN BY:
22-115	RH/AA/DD
SCALE:	DATE:
AS NOTED	2/26/2024
SHEET NUMBER:	

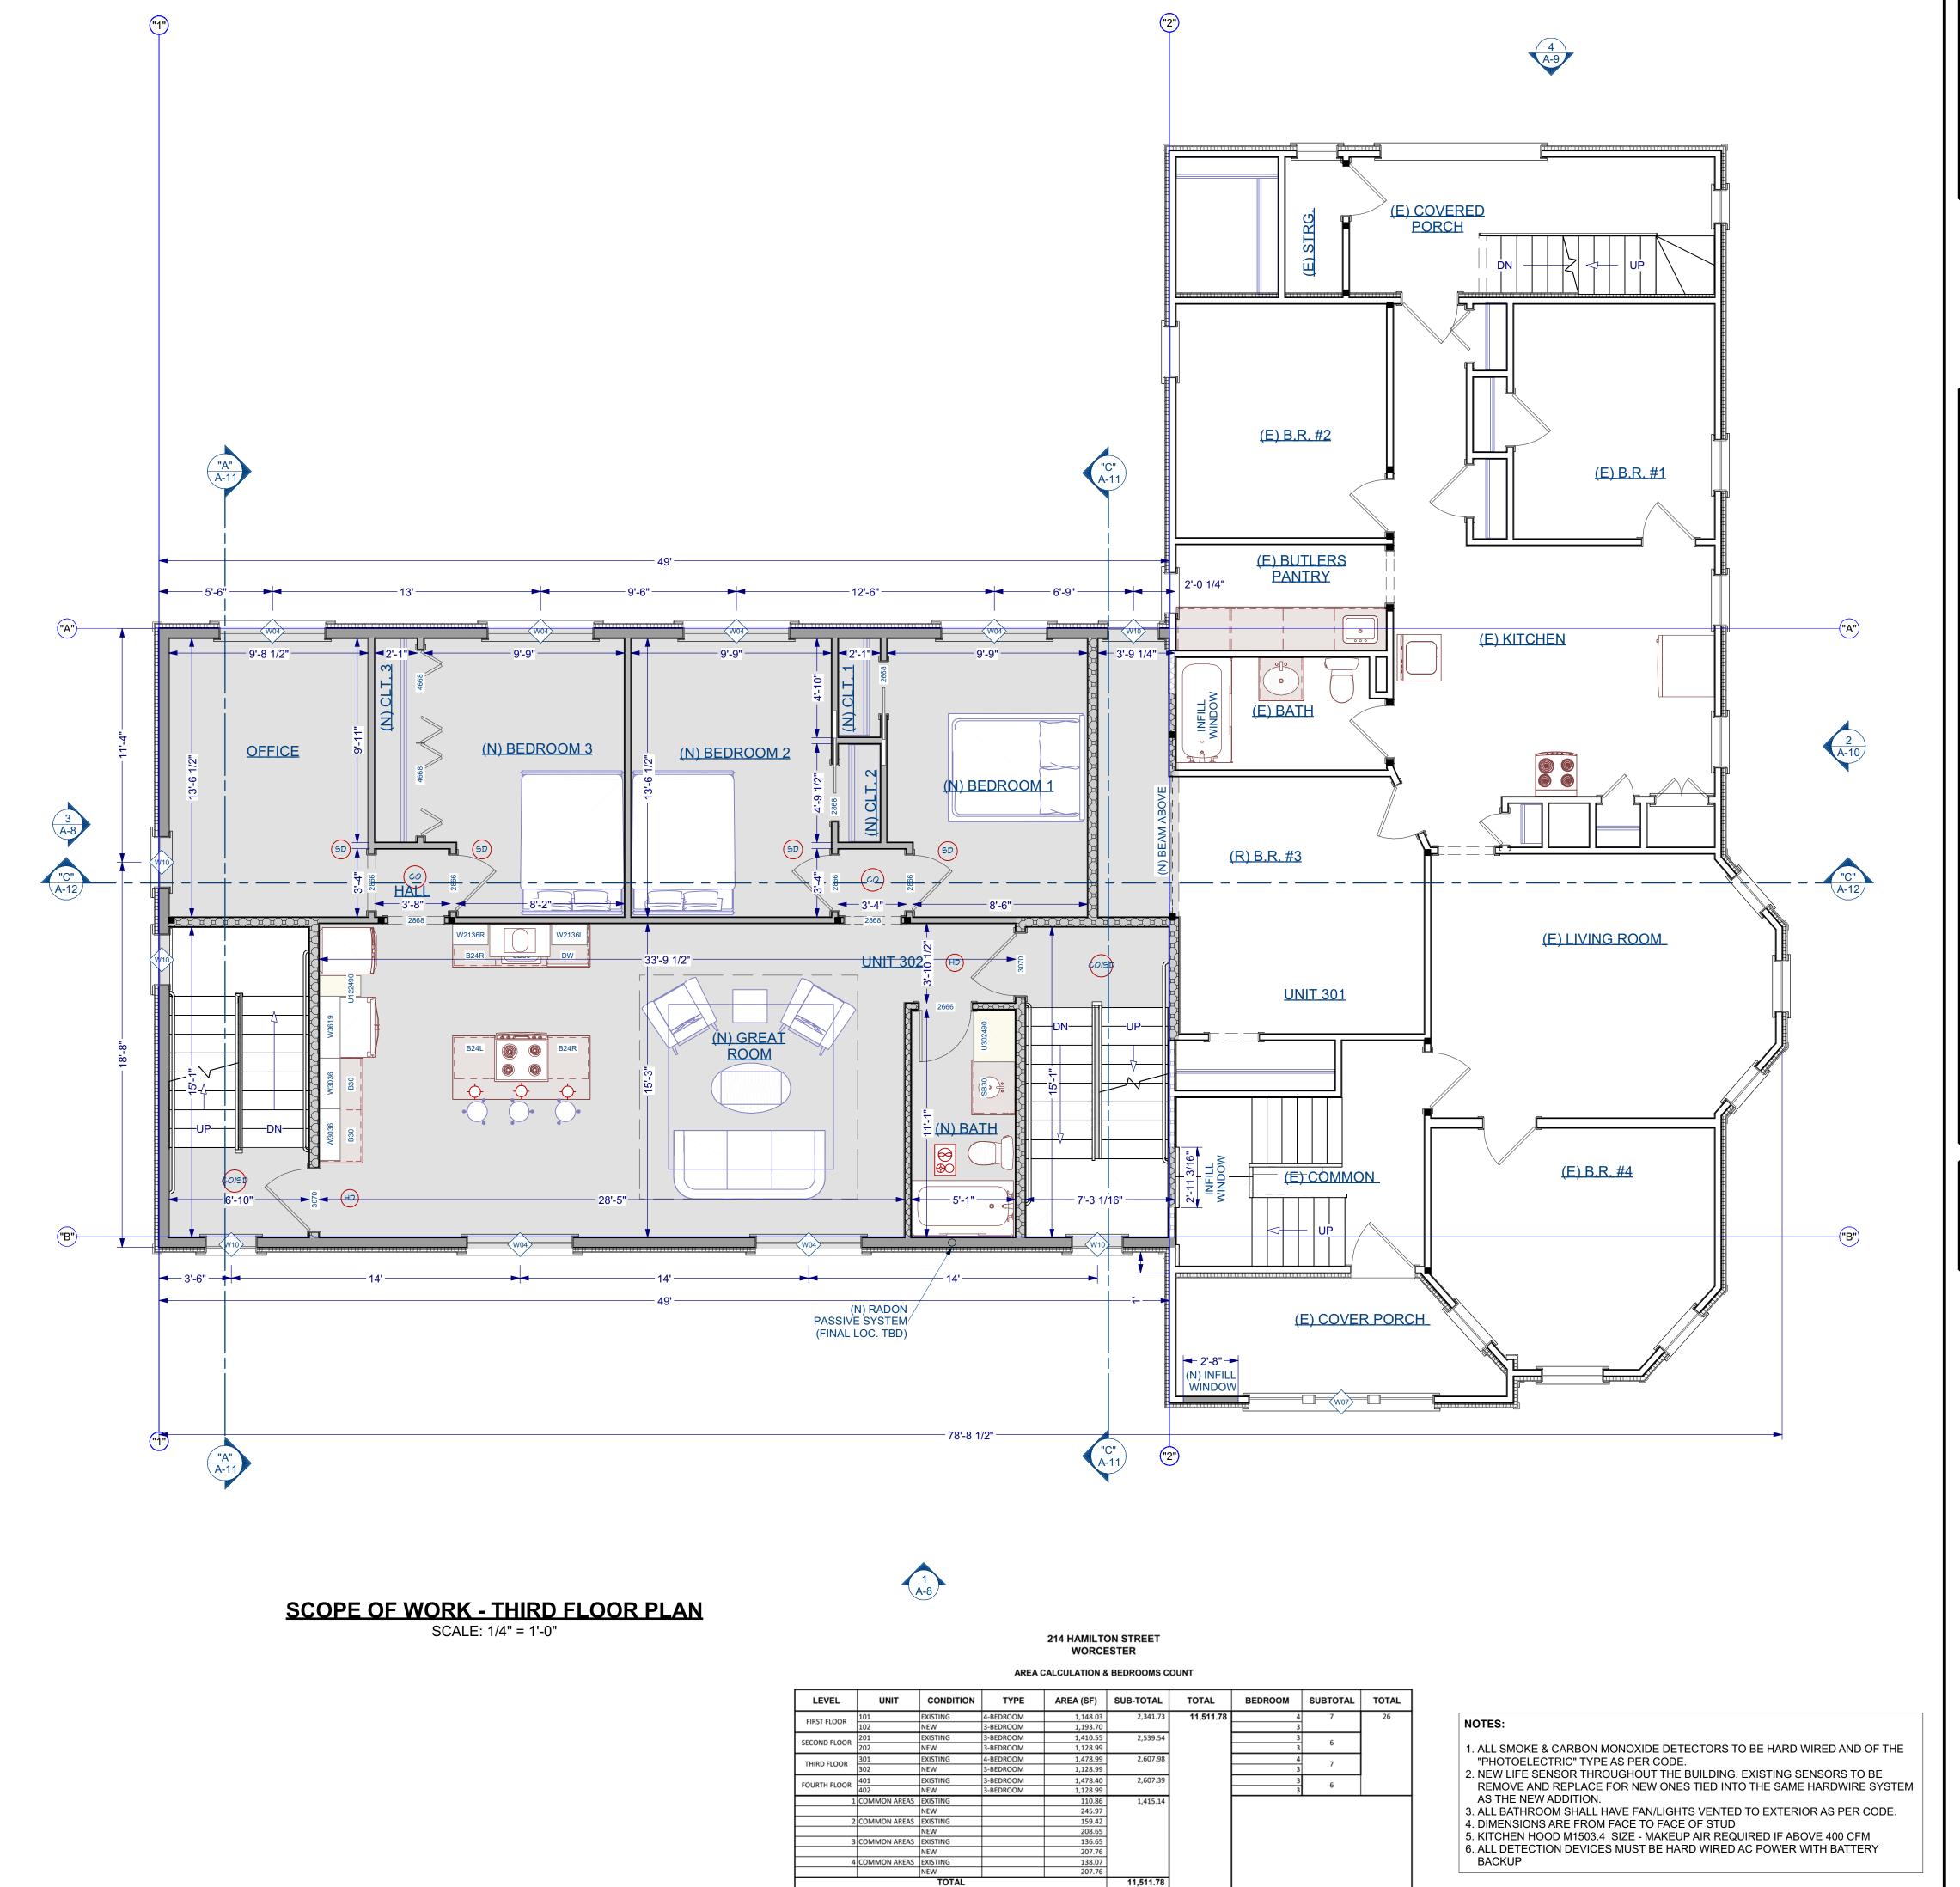

COMMENTS

(N) INTERCONNECTED, HARD-WIRE

& PHOTOELECTRIC

(N) INTERCONNECTED, HARD-WIRE

(N) INTERCONNECTED, HARD-WIRE

& PHOTOELECTRIC

(N) INTERCONNECTED, HARD-WIRE

FAN/LIGHT/HEAT VENT. TO

EXTERIOR

TO OWNER/CONTRACTOR

COMMENTS

& R-10 RIDIG INSULATION

(N) 10" THICK 3,000 PSI CONCRETE FOUNDATION WALL W/ (1) # 5 REBAR AT TOP

& (1) @ MID-HEIGHT, Ø PERFORATED PVC AS FILTER ON EXTERIOR CONNECTED TO

STORM WATER SYSTEM, & DAMPROFFING BELOW GRADE

(N) 2X6 WOOD STUD @ 16" O.C. W/ SIDING, R-

10 RIGID INSULATION ON 1/2" ZIP BOARD, R-

20 CAVITY INSULATION, VAPOR BARRIER ON

INTERIOR FACE AND FINISHES

(N) 2X6 WOOD STUD @ 16" O.C. W/ 5/8" TYPE

"X" ON ONE SIDE & GYPSUM BOARD ON THE

OTHER SIDE. MINERAL WOOD INSULATION

(N) 2X6 WOOD WALL @ 16" O.C. W/SOUND

INSULATION, BLUE BOARD ON THE WET SIDE

AND GYPSUM BOARD ON DRY SIDE

FOR AREA CALCULATION PURPOSES

(N) 2X4 STUD WALL @ 16" O.C. WITH G.W.B.

ON EACH SIDE
(N) 2X4 STUD WALL @ 16" O.C. WITH BLUE

BOARD ON WET SIDE & GYPSUM BOARD ON

DRY SIDE

TO OWNER / CONTRACTOR

TO OWNER / CONTRACTOR

FOR AREA CALCULATION PURPOSES

WALL SCHEDULE

(E) EXTERIOR 2X4 (E) 2X4 WOOD STUD @ 16" O.C. W/ (N) SIDING

DESCRIPTION

SMOKE DETECTOR 1

CO DETECTOR

CO/SMOKE DETECTOR

HEAT DETECTOR

EXHAUST FAN + LIGHT -

HEAT LAMP

CAGED LANTERN

SCONCE

HEAT DETECTOR

BLOWN GLASS PENDANT

SIDING

(N) 10" CONCRETE

STEM WALL

(N)2X6 EXTERIOR

WALL

(N) 2X6 INTERIOR

WALL, FIRE RATED

ROOM DIVIDER

(N) 2X4 INTERIOR

STUD WALL

(N) 2X4 WET WALL

DECK RAILING/

FENCE

INTERIOR RAILING

(N) 2X4 INTERIOR

STUD WALL

DECK RAILING/

FENCE

(N) 2X6 WET WALL

2D SYMBOL WALL TYPE

_ _ _ _ _

SYMBOL

PROJECT NAME:
ADDITION

MULTI-FAMILY BUILDING

214 HAMILTON STREET WORCESTER, MA



5 Brussels Street Building A, Rear 2nd Floor Worcester MA 01610 (D) 774-262-3187 (O) 774-243-6161



REVISION TABLE
NO. DATE DESCRIPTION

PROGRESS
SET FOR
ZONING BOARD
OF APPEALS
USE ONLY

DRAWING NAME:

SCOPE OF WORK - THIRD FLOOR PLAN

PROJECT NUMBER:

22-115

RH/AA/DD


SCALE:

DATE:

AS NOTED

2/26/2024

SHEET NUMBER:

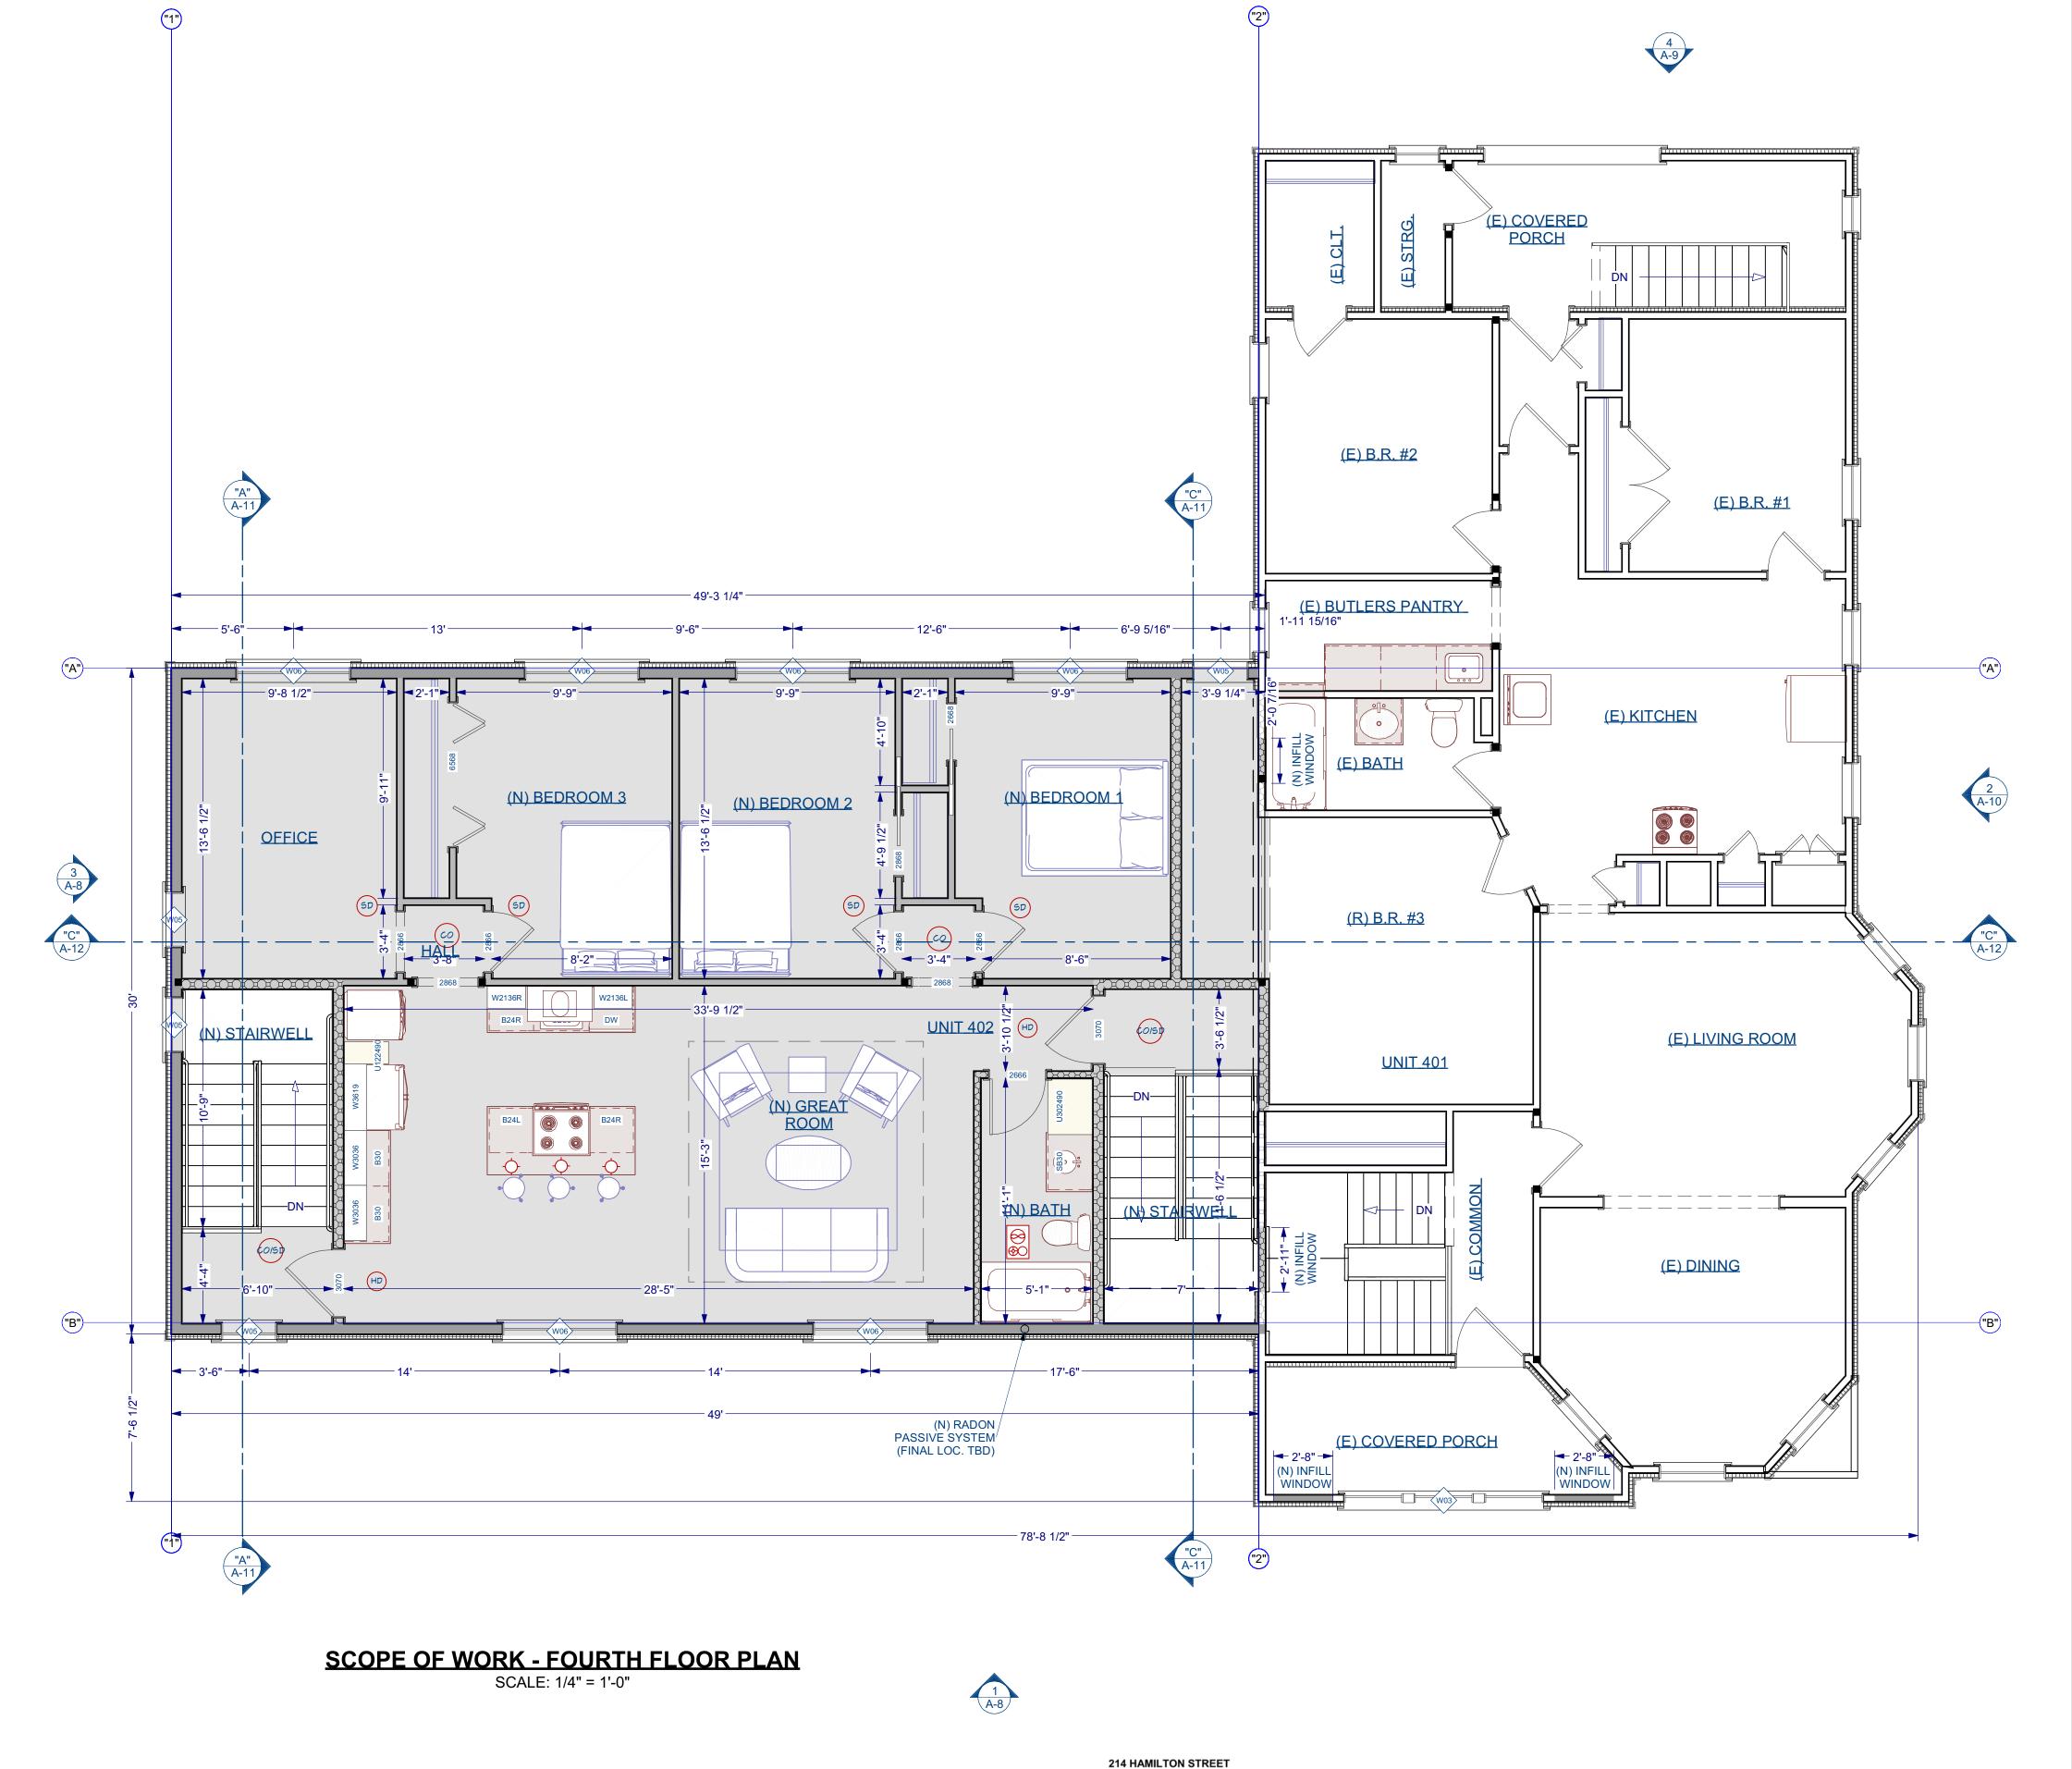

COMMENTS

(N) INTERCONNECTED, HARD-WIRE

& PHOTOELECTRIC

(N) INTERCONNECTED, HARD-WIRE

(N) INTERCONNECTED, HARD-WIRE

& PHOTOELECTRIC

(N) INTERCONNECTED, HARD-WIRE

FAN/LIGHT/HEAT VENT. TO

EXTERIOR

TO OWNER/CONTRACTOR

COMMENTS

& R-10 RIDIG INSULATION (N) 10" THICK 3,000 PSI CONCRETE

FOUNDATION WALL W/ (1) # 5 REBAR AT TOP

& (1) @ MID-HEIGHT, Ø PERFORATED PVC AS FILTER ON EXTERIOR CONNECTED TO

STORM WATER SYSTEM, & DAMPROFFING **BELOW GRADE** (N) 2X6 WOOD STUD @ 16" O.C. W/ SIDING, R-

10 RIGID INSULATION ON 1/2" ZIP BOARD, R-

20 CAVITY INSULATION, VAPOR BARRIER ON

INTERIOR FACE AND FINISHES

(N) 2X6 WOOD STUD @ 16" O.C. W/ 5/8" TYPE

"X" ON ONE SIDE & GYPSUM BOARD ON THE

OTHER SIDE. MINERAL WOOD INSULATION

(N) 2X6 WOOD WALL @ 16" O.C. W/SOUND

INSULATION, BLUE BOARD ON THE WET SIDE

AND GYPSUM BOARD ON DRY SIDE

FOR AREA CALCULATION PURPOSES

(N) 2X4 STUD WALL @ 16" O.C. WITH G.W.B.

ON EACH SIDE

(N) 2X4 STUD WALL @ 16" O.C. WITH BLUE

BOARD ON WET SIDE & GYPSUM BOARD ON

DRY SIDE

TO OWNER / CONTRACTOR

TO OWNER / CONTRACTOR

FOR AREA CALCULATION PURPOSES

DESCRIPTION

SMOKE DETECTOR 1

CO DETECTOR

CO/SMOKE DETECTOR

HEAT DETECTOR

EXHAUST FAN + LIGHT +

HEAT LAMP

CAGED LANTERN

SCONCE

HEAT DETECTOR

BLOWN GLASS PENDANT

SIDING

(N) 10" CONCRETE

STEM WALL

(N)2X6 EXTERIOR

WALL

(N) 2X6 INTERIOR

WALL, FIRE RATED

ROOM DIVIDER

(N) 2X4 INTERIOR

STUD WALL

DECK RAILING/

FENCE

INTERIOR RAILING

(N) 2X4 INTERIOR

STUD WALL

DECK RAILING/

FENCE

(N) 2X6 WET WALL

(N) 2X4 WET WALL

2D SYMBOL WALL TYPE

AAAAAA

WALL SCHEDULE

(E) EXTERIOR 2X4 (E) 2X4 WOOD STUD @ 16" O.C. W/ (N) SIDING

SYMBOL

WORCESTER AREA CALCULATION & BEDROOMS COUNT

		CONDITION	TYPE	AREA (SF)	SUB-TOTAL	TOTAL	BEDROOM	SUBTOTAL	TOTAL
FIRST FLOOR	101	EXISTING	4-BEDROOM	1,148.03	2,341.73	11,511.78	4	7	26
FIRST FLOOR	102	NEW	3-BEDROOM	1,193.70			3		
ECOND FLOOR	201	EXISTING	3-BEDROOM	1,410.55	2,539.54		3	6	
ECOND FLOOR	202	NEW	3-BEDROOM	1,128.99			3	ь	
THIRD FLOOR	301	EXISTING	4-BEDROOM	1,478.99	2,607.98		4	7	
THIRD FLOOR	302	NEW	3-BEDROOM	1,128.99			3	′	
OURTH FLOOR	401	EXISTING	3-BEDROOM	1,478.40	2,607.39		3		
JOKIH FLOOK	402	NEW	3-BEDROOM	1,128.99			3	6	
1	COMMON AREAS	EXISTING		110.86	1,415.14				
		NEW		245.97					
2	COMMON AREAS	EXISTING		159.42					
		NEW		208.65					
3	COMMON AREAS	EXISTING		136.65					
		NEW		207.76					
4	COMMON AREAS	EXISTING		138.07					
		NEW		207.76					

BACKUP

- 1. ALL SMOKE & CARBON MONOXIDE DETECTORS TO BE HARD WIRED AND OF THE
- "PHOTOELECTRIC" TYPE AS PER CODE. 2. NEW LIFE SENSOR THROUGHOUT THE BUILDING. EXISTING SENSORS TO BE REMOVE AND REPLACE FOR NEW ONES TIED INTO THE SAME HARDWIRE SYSTEM
- AS THE NEW ADDITION.
- 3. ALL BATHROOM SHALL HAVE FAN/LIGHTS VENTED TO EXTERIOR AS PER CODE. 4. DIMENSIONS ARE FROM FACE TO FACE OF STUD

5. KITCHEN HOOD M1503.4 SIZE - MAKEUP AIR REQUIRED IF ABOVE 400 CFM 6. ALL DETECTION DEVICES MUST BE HARD WIRED AC POWER WITH BATTERY **ADDITION**

MULTI-FAMILY BUILDING



214 HAMILTON STREET WORCESTER, MA

5 Brussels Street Building A, Rear 2nd Floor (D) 774-262-3187 (O) 774-243-6161




PROGRESS SET FOR **ZONING BOARD** OF APPEALS **USE ONLY**

DRAWING NAME:

SCOPE OF WORK - FOURTH FLOOR PLAN

ı	PROJECT NUMBER:	DRAWN BY:
	22-115	RH/AA/DD
ı	SCALE:	DATE:
	AS NOTED	2/26/2024
ı	SHEET NUMBER:	

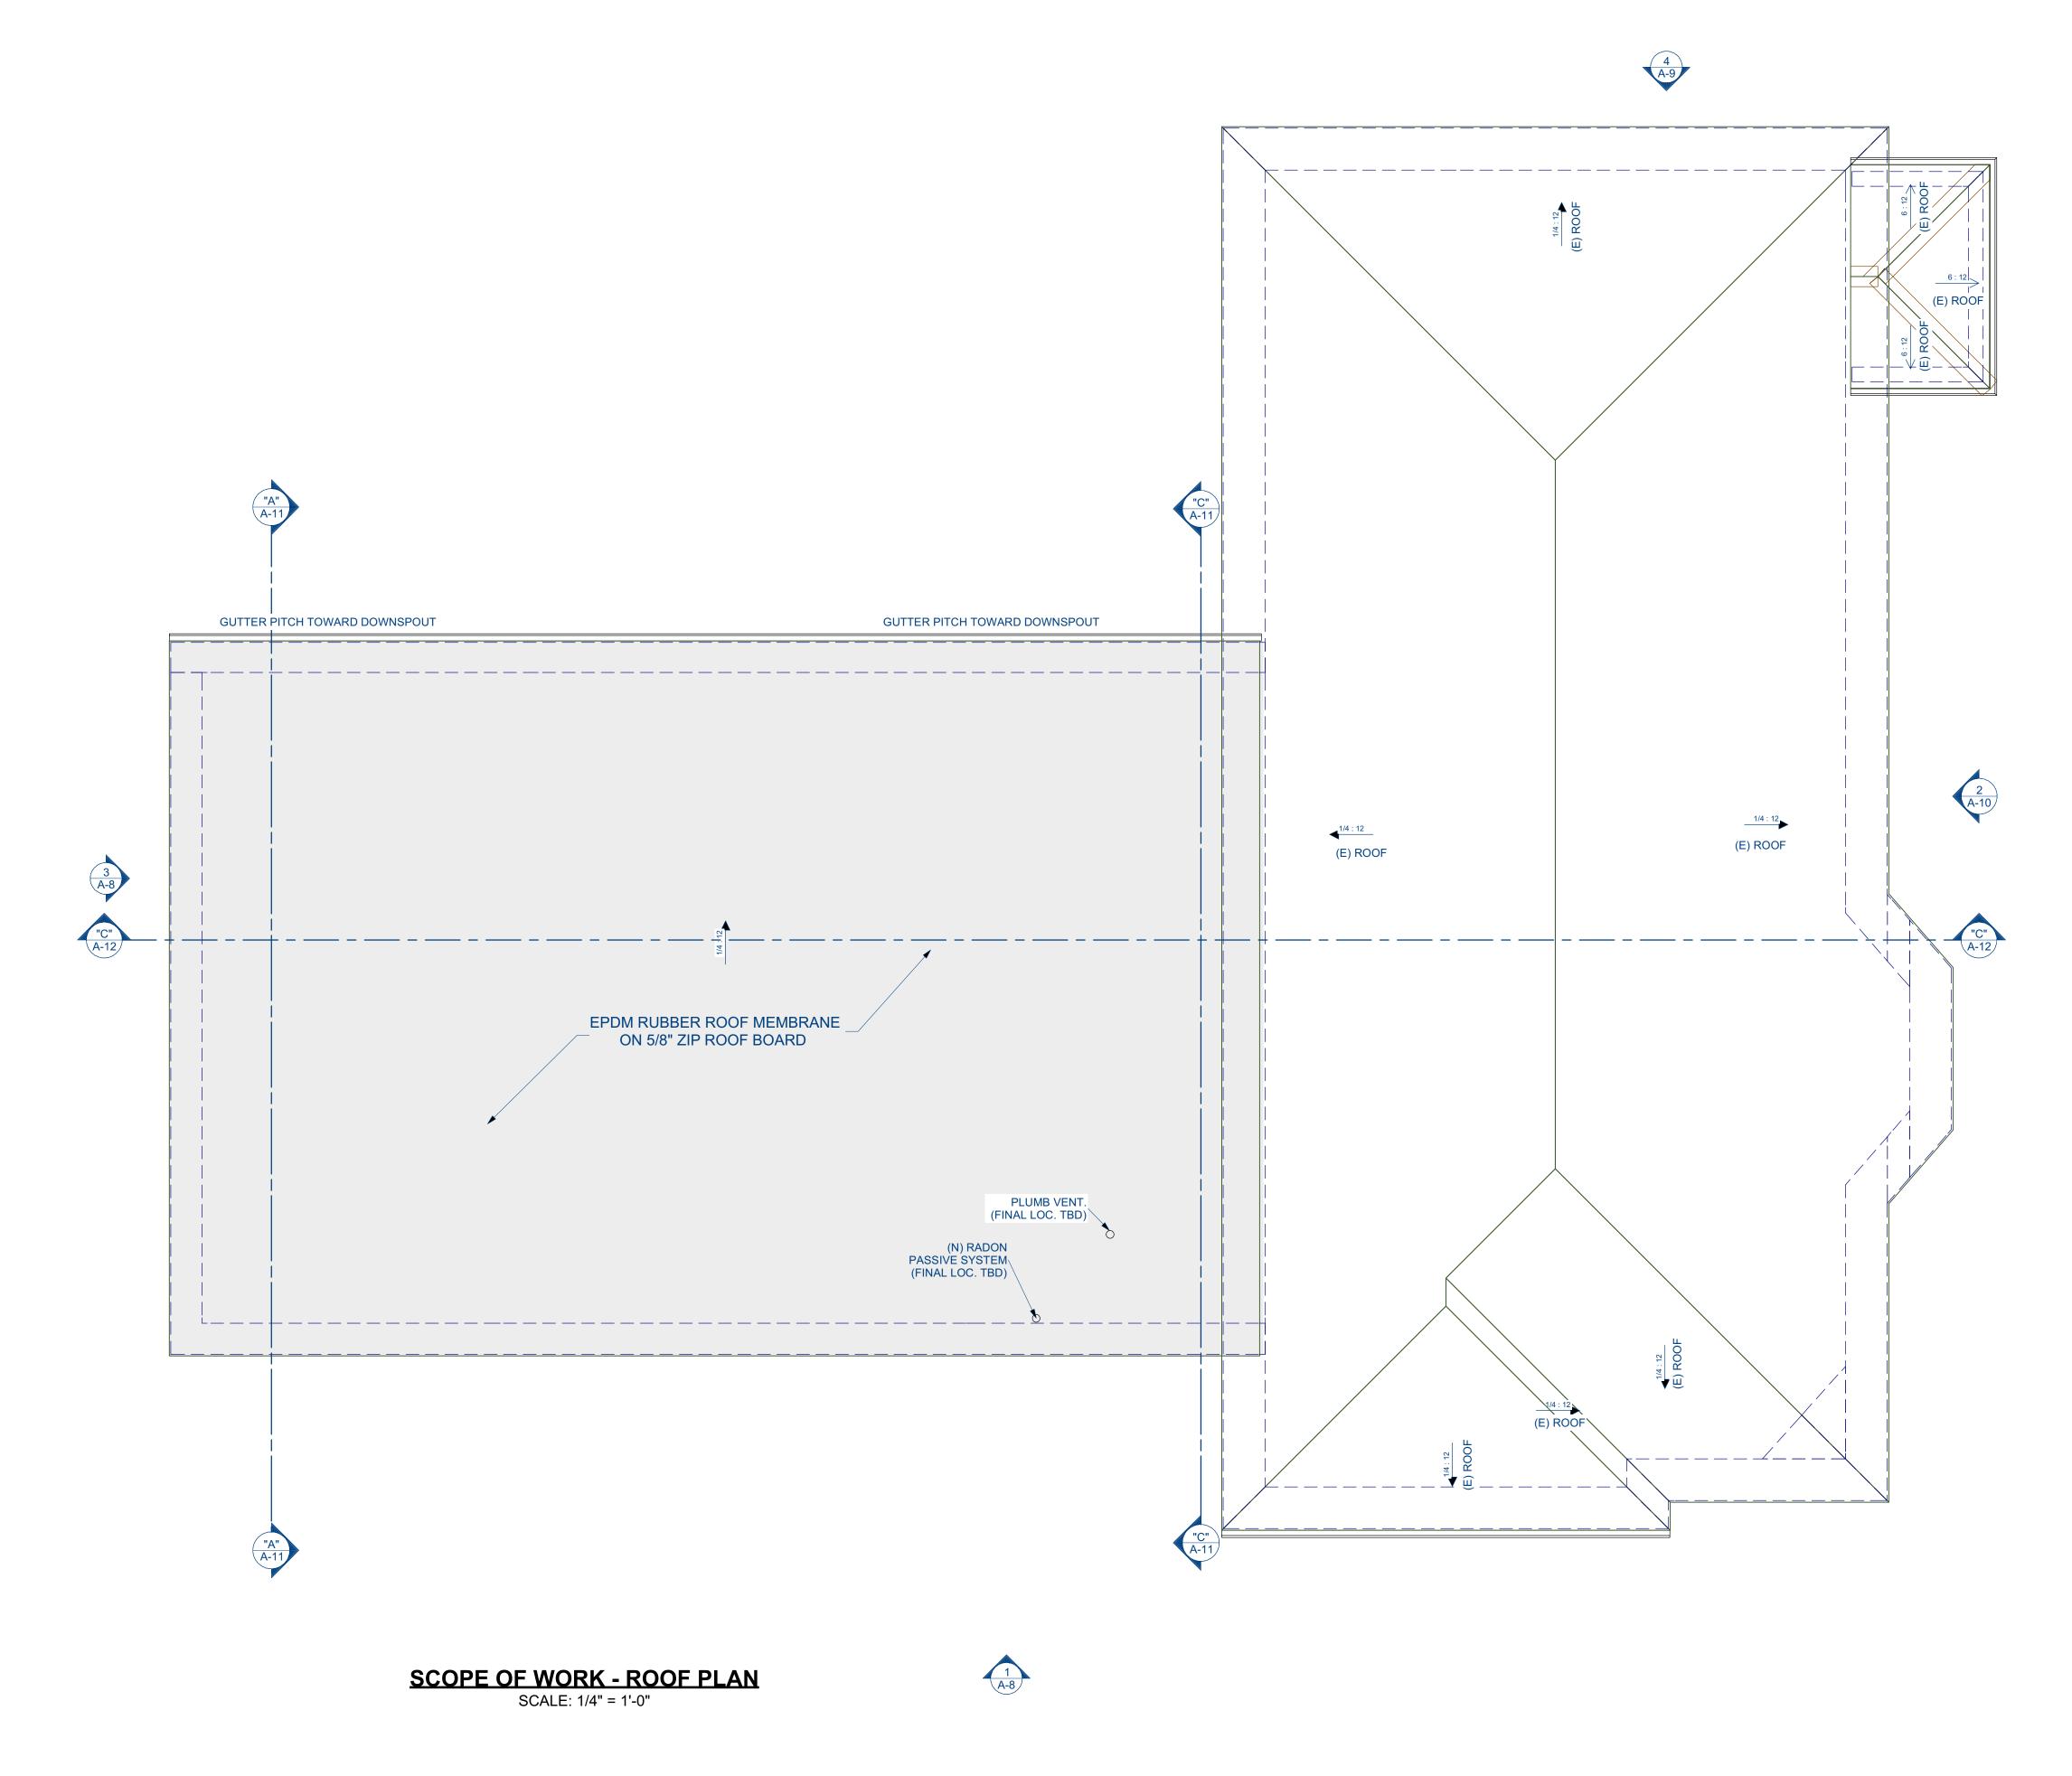

- 1. ALL SMOKE & CARBON MONOXIDE DETECTORS TO BE HARD WIRED AND OF THE "PHOTOELECTRIC" TYPE AS PER CODE.

 2. NEW LIFE SENSOR THROUGHOUT THE BUILDING. EXISTING SENSORS TO BE REMOVE AND REPLACE FOR NEW ONES TIED INTO THE SAME HARDWIRE SYSTEM AS THE NEW ADDITION.
- 3. ALL BATHROOM SHALL HAVE FAN/LIGHTS VENTED TO EXTERIOR AS PER CODE.
 4. DIMENSIONS ARE FROM FACE TO FACE OF STUD
 5. KITCHEN HOOD M1503.4 SIZE MAKEUP AIR REQUIRED IF ABOVE 400 CFM
- 6. ALL DETECTION DEVICES MUST BE HARD WIRED AC POWER WITH BATTERY BACKUP

ADDITION

MULTI-FAMILY BUILDING

214 HAMILTON STREET WORCESTER, MA

5 Brussels Street Building A, Rear 2nd Floor Worcester MA 01610 (D) 774-262-3187 (O) 774-243-6161 Info@acropolisdesign.org



PROGRESS SET FOR **ZONING BOARD** OF APPEALS **USE ONLY**

SCOPE OF WORK -ROOF PLAN

RH/AA/DD 22-115 AS NOTED 2/26/2024 SHEET NUMBER:









PROPOSED - RENDERINGS
SCALE: NOT TO SCALE

ADDITION

MULTIFAMILY
BUILDING


ACROPOLIS

DESIGN CONSULTANTS

774-262-3187

214 HAMILTON STREET WORCESTER, MA

5 Brussels Street Building A, Rear 2nd Floor Worcester MA 01610 (D) 774-262-3187 (O) 774-243-6161 Info@acropolisdesign.org

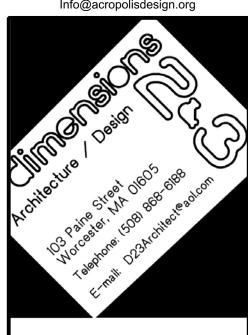

REVISION TABLE
NO. DATE DESCRIPTION

PROGRESS
SET FOR
ZONING BOARD
OF APPEALS
USE ONLY

DRAWING NAME:

PROPOSED -RENDERINGS

	PROJECT NUMBER:	DRAWN BY:
	22-115	RH/AA/DD
	SCALE:	DATE:
	AS NOTED	2/26/2024
	SHEET NUMBER:	



SCOPE OF WORK - FRONT ELEVATION



DOOR AND WINDOW NOTES:

• EVERY BEDROOM SHALL BE PROVIDED WITH AN EGRESS WINDOW WITH FINISH SILL HEIGHT NOT GREATER THAN 44" ABOVE THE FINISH FLOOR HEIGHT AND SHALL HAVE A MINIMUM OPERABLE AREA OF 5.7 SQ. FT. EGRESS WINDOWS SHALL NOT HAVE AN OPERABLE AREA LESS THAN 20" WIDE OR 24" HIGH.

• ALL WALK-THRU DOORS SHALL BE SOLID CORE

• INTERIOR DOORS SHALL BE PAINTED. ENTRY DOOR TO BE DEFINED BY HOME OWNER PRIOR TO ORDERING

• EXTERIOR EXIT DOORS WILL BE 36" MIN. NET CLEAR DOORWAY SHALL BW 32" MIN. DOOR SHALL BE OPERABLE FROM INSIDE WITHOUT THE USE OF A KEY OR ANY SPECIAL KNOWLEDGE OR EFFORT. GLAZING IN DOORS SHALL BE DUAL PANEL SAFETY

FLOORS AND ROOFS

• ALL EXPOSED INSULATION IS TO HAVE A FLAME SPREAD RATING OF LESS THEN 25 AND A SMOKE DENSITY RATING OF LESS THAN 450.

• PROVIDE INSULATION BAFFLES AT EAVE VENTS BETWEEN RAFTERS.

• SPECIFIC MANUFACTURES AND MODEL NUMBERS SHOWN ON THE PLANS ARE INDICATIONS OF QUALITY ONLY. THE OWNER/BUILDER SHALL NOT BE PROHIBITED FROM SUBSTITUTING MATERIALS AND/ OR APPLIANCES OF EQUAL QUALITY/STRENGTHS FROM NON-SPECIFIED MANUFACTURERS.

• THE OWNER/BUILDER SHALL NOT BE SUBSTITUTING MATERIALS PROVIDED THEY MEET CURRENT BLDG. CODE, AND ARE APPROVED FOR THAT SPECIFIC USE BY THE BUILDING OFFICIAL

FINISH NOTES:

• RENDERINGS ARE NOT TO SCALE; ALL RENDERINGS ARE FOR ARTISTIC DEPICTION ONLY. PLAN UPDATES MAY NOT BE REFLECTED IN RENDERINGS. RENDERINGS SHALL NOT BE USED FOR CONSTRUCTION.

• BASE BOARDS SHALL BE 6" IN ALL ROOMS.

• FINAL FINISHES SHALL BE CONFIRMED WITH THE HOME OWNER PRIOR TO APPLICATION.

EXTERIOR NARRATIVE:

• INSPECT SIDING, IF DAMAGED THEN REMOVE AND REPLACE WITH MATCHING VINYL SIDING.

• MATCH SIDING ON ALL NEW INFILLED AREAS.

• REMOVE EXISTING PORCH WINDOWS AND ADD NEW OPENING TO CREATE OPEN PORCH.

• VERIFY DRAINAGE OF EXISTING PORCH OR INSTALL NEW SCUPPERS.

• INSPECT DENTAL ON EXISTING BUILDING, IF DAMAGED THEN REMOVE AND REPLACE WITH SIMILAR STYLE

• NEW DENTAL AROUND NEW ADDITION TO MATCH EXISTING

• ANY ADDITIONAL SCOPE TO BE REQUIRED SHALL BE COORDINATED WITH DESIGNER.

WINDOWS NOTE:

IF AN OPERABLE WINDOW IS LOCATED LESS THAN 24"ABOVE FINISH FLOOR (A.F.F.), MUST HAVE A WINDOW FALL PROTECTION DEVICE AS PER R312.2

ADDITION

MULTI-FAMILY BUILDING

214 HAMILTON STREET WORCESTER, MA



5 Brussels Street Building A, Rear 2nd Floor Worcester MA 01610 (D) 774-262-3187 (O) 774-243-6161




PROGRESS SET FOR **ZONING BOARD** OF APPEALS **USE ONLY**

SCOPE OF WORK - FRONT & LEFT **ELEVATION**

PROJECT NUMBER:	DRAWN BY:
22-115	RH/AA/DD
SCALE:	DATE:
AS NOTED	2/26/2024
SHEET NUMBER:	



SCALE: 1/4" = 1'-0"

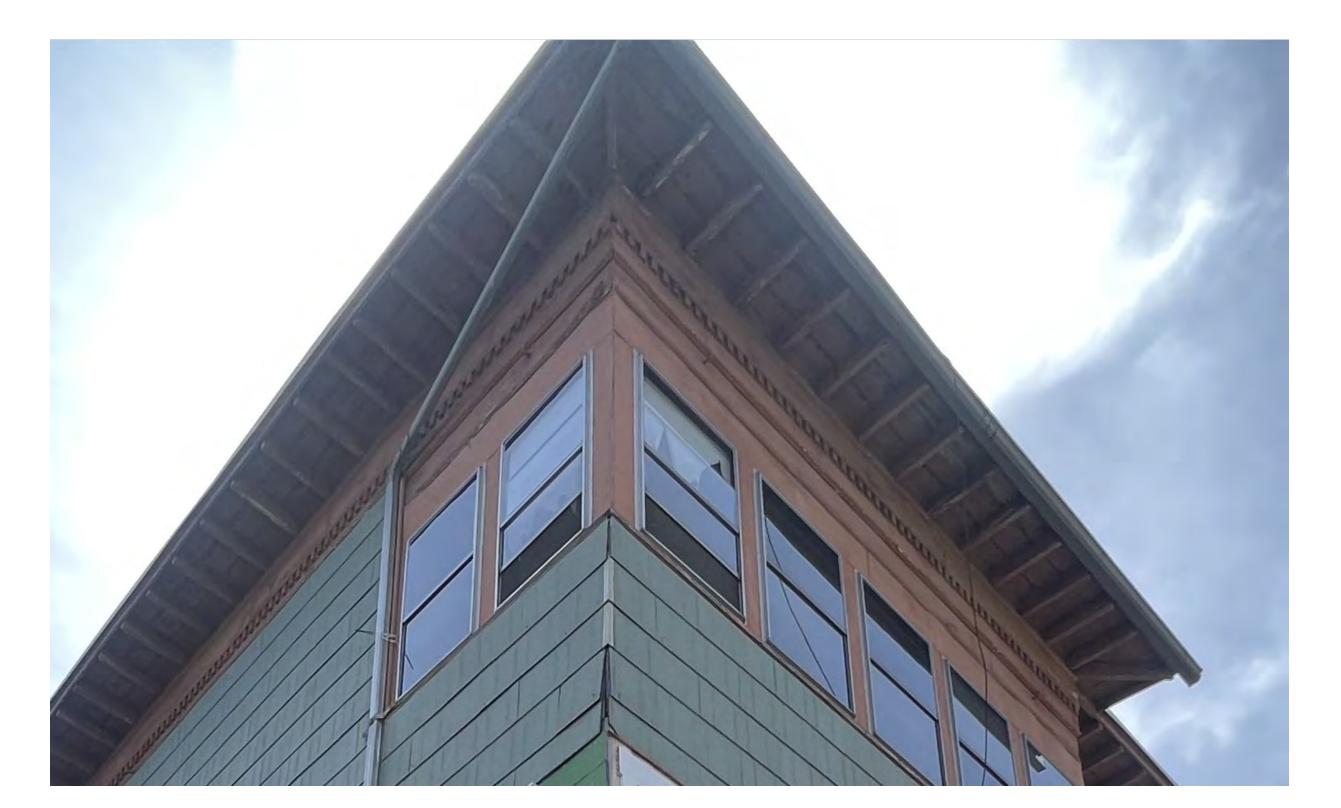

EXISTING ROOF DENTAL SCALE: NOT TO SCALE



PROPOSED DENTAL TRIM

SCALE: NOT TO SCALE

DOOR AND WINDOW NOTES:

• EVERY BEDROOM SHALL BE PROVIDED WITH AN EGRESS WINDOW WITH FINISH SILL HEIGHT NOT GREATER THAN 44" ABOVE THE FINISH FLOOR HEIGHT AND SHALL HAVE A MINIMUM OPERABLE AREA OF 5.7 SQ. FT. EGRESS WINDOWS SHALL NOT HAVE AN OPERABLE AREA LESS THAN 20" WIDE OR 24" HIGH.

• ALL WALK-THRU DOORS SHALL BE SOLID CORE

• INTERIOR DOORS SHALL BE PAINTED. ENTRY DOOR TO BE DEFINED BY HOME OWNER PRIOR TO ORDERING

• EXTERIOR EXIT DOORS WILL BE 36" MIN. NET CLEAR DOORWAY SHALL BW 32" MIN. DOOR SHALL BE OPERABLE FROM INSIDE WITHOUT THE USE OF A KEY OR ANY SPECIAL KNOWLEDGE OR EFFORT. GLAZING IN DOORS SHALL BE DUAL PANEL SAFETY GLASS WITH MIN. U-VALUE OF 0.60

FLOORS AND ROOFS

• ALL EXPOSED INSULATION IS TO HAVE A FLAME SPREAD RATING OF LESS THEN 25 AND A SMOKE DENSITY RATING OF LESS THAN 450.

• PROVIDE INSULATION BAFFLES AT EAVE VENTS BETWEEN RAFTERS.

• SPECIFIC MANUFACTURES AND MODEL NUMBERS SHOWN ON THE PLANS ARE INDICATIONS OF QUALITY ONLY. THE OWNER/BUILDER SHALL NOT BE PROHIBITED FROM SUBSTITUTING MATERIALS AND/ OR APPLIANCES OF EQUAL QUALITY/STRENGTHS FROM NON-SPECIFIED MANUFACTURERS.

• THE OWNER/BUILDER SHALL NOT BE SUBSTITUTING MATERIALS PROVIDED THEY MEET CURRENT BLDG. CODE, AND ARE APPROVED FOR THAT SPECIFIC USE BY THE BUILDING OFFICIAL

FINISH NOTES:

• RENDERINGS ARE NOT TO SCALE; ALL RENDERINGS ARE FOR ARTISTIC DEPICTION ONLY. PLAN UPDATES MAY NOT BE REFLECTED IN RENDERINGS. RENDERINGS SHALL NOT BE USED FOR CONSTRUCTION.

• BASE BOARDS SHALL BE 6" IN ALL ROOMS.

• FINAL FINISHES SHALL BE CONFIRMED WITH THE HOME OWNER PRIOR TO APPLICATION.

EXTERIOR NARRATIVE:

• INSPECT SIDING, IF DAMAGED THEN REMOVE AND REPLACE WITH MATCHING VINYL SIDING.

• MATCH SIDING ON ALL NEW INFILLED AREAS.

• REMOVE EXISTING PORCH WINDOWS AND ADD NEW OPENING TO CREATE OPEN PORCH.

• VERIFY DRAINAGE OF EXISTING PORCH OR INSTALL NEW SCUPPERS.

• INSPECT DENTAL ON EXISTING BUILDING, IF DAMAGED THEN REMOVE AND REPLACE WITH SIMILAR STYLE

• NEW DENTAL AROUND NEW ADDITION TO MATCH EXISTING

• ANY ADDITIONAL SCOPE TO BE REQUIRED SHALL BE COORDINATED WITH DESIGNER.

WINDOWS NOTE:

IF AN OPERABLE WINDOW IS LOCATED LESS THAN 24"ABOVE FINISH FLOOR (A.F.F.), MUST HAVE A WINDOW FALL PROTECTION DEVICE AS PER R312.2

ADDITION

MULTI-

FAMILY

BUILDING

214 HAMILTON STREET WORCESTER, MA

5 Brussels Street Building A, Rear 2nd Floor

Worcester MA 01610

(D) 774-262-3187 (O) 774-243-6161

Info@acropolisdesign.org

PROGRESS SET FOR **ZONING BOARD** OF APPEALS **USE ONLY**

SCOPE OF WORK - RIGHT **ELEVATION**

PROJECT NUMBER:	DRAWN BY:
22-115	RH/AA/DI
SCALE:	DATE:
AS NOTED	2/26/202
SHEET NUMBER:	



SCOPE OF WORK - RIGHT ELEVATION

SCALE: 1/4" = 1'-0"

DOOR AND WINDOW NOTES:

• EVERY BEDROOM SHALL BE PROVIDED WITH AN EGRESS WINDOW WITH FINISH SILL HEIGHT NOT GREATER THAN 44" ABOVE THE FINISH FLOOR HEIGHT AND SHALL HAVE A MINIMUM OPERABLE AREA OF 5.7 SQ. FT. EGRESS WINDOWS SHALL NOT HAVE AN OPERABLE AREA LESS THAN 20" WIDE OR 24" HIGH.

• ALL WALK-THRU DOORS SHALL BE SOLID CORE

• INTERIOR DOORS SHALL BE PAINTED. ENTRY DOOR TO BE DEFINED BY HOME OWNER PRIOR TO ORDERING

• EXTERIOR EXIT DOORS WILL BE 36" MIN. NET CLEAR DOORWAY SHALL BW 32" MIN. DOOR SHALL BE OPERABLE FROM INSIDE WITHOUT THE USE OF A KEY OR ANY SPECIAL KNOWLEDGE OR EFFORT. GLAZING IN DOORS SHALL BE DUAL PANEL SAFETY GLASS WITH MIN. U-VALUE OF 0.60

FLOORS AND ROOFS

• ALL EXPOSED INSULATION IS TO HAVE A FLAME SPREAD RATING OF LESS THEN 25 AND A SMOKE DENSITY RATING OF LESS THAN 450.

 PROVIDE INSULATION BAFFLES AT EAVE VENTS BETWEEN RAFTERS.

• SPECIFIC MANUFACTURES AND MODEL NUMBERS SHOWN ON THE PLANS ARE INDICATIONS OF QUALITY ONLY. THE OWNER/BUILDER SHALL NOT BE PROHIBITED FROM SUBSTITUTING MATERIALS AND/ OR APPLIANCES OF EQUAL QUALITY/STRENGTHS FROM NON-SPECIFIED MANUFACTURERS.

THE OWNER/BUILDER SHALL NOT BE SUBSTITUTING MATERIALS
 PROVIDED THEY MEET CURRENT BLDG. CODE, AND ARE
 APPROVED FOR THAT SPECIFIC USE BY THE BUILDING OFFICIAL

FINISH NOTES:

 RENDERINGS ARE NOT TO SCALE; ALL RENDERINGS ARE FOR ARTISTIC DEPICTION ONLY. PLAN UPDATES MAY NOT BE REFLECTED IN RENDERINGS. RENDERINGS SHALL NOT BE USED FOR CONSTRUCTION.

• BASE BOARDS SHALL BE 6" IN ALL ROOMS.

• FINAL FINISHES SHALL BE CONFIRMED WITH THE HOME OWNER PRIOR TO APPLICATION.

EXTERIOR NARRATIVE:

• INSPECT SIDING, IF DAMAGED THEN REMOVE AND REPLACE WITH MATCHING VINYL SIDING.

• MATCH SIDING ON ALL NEW INFILLED AREAS.

 REMOVE EXISTING PORCH WINDOWS AND ADD NEW OPENING TO CREATE OPEN PORCH.

 VERIFY DRAINAGE OF EXISTING PORCH OR INSTALL NEW SCUPPERS.

• INSPECT DENTAL ON EXISTING BUILDING, IF DAMAGED THEN

NEW DENTAL AROUND NEW ADDITION TO MATCH EXISTING

• ANY ADDITIONAL SCOPE TO BE REQUIRED SHALL BE COORDINATED WITH DESIGNER.

REMOVE AND REPLACE WITH SIMILAR STYLE

WINDOWS NOTE:

IF AN OPERABLE WINDOW IS LOCATED LESS THAN 24"ABOVE FINISH FLOOR (A.F.F.), MUST HAVE A WINDOW FALL PROTECTION DEVICE AS PER R312.2

MULTI-FAMILY BUILDING

ADDITION

214 HAMILTON STREET WORCESTER, MA

DESIGN CONSULTANTS
774-262-3187
5 Brussels Street
Building A, Rear 2nd Floor

Worcester MA 01610

(D) 774-262-3187



REVISION TABLE

NO. DATE DESCRIPTION

CTAMD

PROGRESS
SET FOR
ZONING BOARD
OF APPEALS
USE ONLY

WING NAME:

SCOPE OF WORK - RIGHT ELEVATION

	PROJECT NUMBER:	DRAWN BY:
	22-115	RH/AA/DD
	SCALE:	DATE:
	AS NOTED	2/26/2024